

ARCHITECTURAL PLAN - BASEMENT
SCALE: 1/4" = 1'-0"

ARCHITECTURAL GENERAL NOTES:

- I. ALL INTERIOR FINISHES TO COMPLY WITH SECTION 15-8-420 C.B./15-8-440 C.B.C.
- 2. ALL EXIT DOORS TO REMAIN KEYLESS IN THE DIRECTION OF EGRESS.
- 3. ALL GLASS TO COMPLY WITH SECTION 13-124-350 C.B.C. AND SHALL BE SAFETY GLAZED.
- 4. ALL MATERIALS FOR INTERIOR FINISHES FOR WALLS AND CEILING SHALL NOT BE LESS RESISTANT TO FLAME SPREAD THAN CLASS I.
- 5. ALL FLOOR COVERING SHALL MEET CLASS "A" REQUIREMENTS.
- MATER RESISTANT GYPSUM BACKER BOARD IS REQUIRED AROUND ALL TUB AND SHOMER WALLS.
- 7. PROVIDE TEMPERED GLASS IN ALL PATIO DOORS AND BATHROOM WINDOWS.

MINDOM SCHEDULE

| - 1 | | | | | | | | |
|-----|--------------|-------------|----------------|--------------|-----------------|-----------------------|----------------------|---------|
| | TAG | TYPE | <u>SIZE</u> | <u> QTY.</u> | <u>LOCATION</u> | <u>LIGHT</u> (SF.) | <u>VENT</u> (SF.) | REMARKS |
| | W6 | DOUBLE-HUNG | 3'-4" × 5'-0" | 8 | LIVING | 15 | 7.5 | |
| | (<u>A</u>) | DOUBLE-HUNG | 2'-II" X 5'-0" | 2 | BED | 14.17 | 7.08 | |
| | (NB) | DOUBLE-HUNG | 2'-8" × 5'-0" | 2 | BED | 13.33 | 6.67 | |

DOOR SCHEDULE

| TAG | TYPE | SIZE | <u> </u> | <u>LOCATION</u> | HARDWARE | FRAME | REMARKS |
|-----|---------|---------------|----------|------------------|----------|-------|---------|
| | SMING | 3'-0" × 7'-0" | 4 | ALL ENTRY POINTS | I | MD. | |
| 2 | SMING | 2'-8" × 7'-0" | 2 | BEDROOMS | 2 | MD. | |
| 3 | SMING | 3'-0" × 7'-0" | 2 | UTILTY | 3 | MD. | |
| 4 | SMING | 2'-4" × 7'-0" | 8 | BATHROOMS | 2 | MD. | |
| 5 | SLIDING | 4'-0" × 7'-0" | 2 | CLOSETS | 4 | MD. | |


HARDWARE SCHEDULE

| MARK | <u>FUNCTION</u> | <u>REMARKS</u> |
|------|-----------------|---|
| | BUILDING ENTRY | ENTRY LOCKSET, DOOR STOP & WEATHERSTRIPPING |
| 2 | PRIVACY | PRIVACY LOCKSET, DOOR STOP |
| 3 | PASSAGE | PASSAGE LOCKSET, DOOR STOP |
| 4 | CLOSET | DUMMY KNOB, DOOR STOP |
| | 2 | BUILDING ENTRY 2 PRIVACY 3 PASSAGE |

MALL LEGEND:



MALL TYPE SCHEDULE: N.T.S.

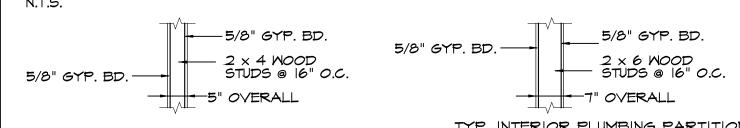

OTITYP INTERIOR PARTITION (ONE HOUR - UL# U419)

| | |
|---------------|--|
| | TYP. INTERIOR PLUMBING PARTITION |
| $\mathbb{C}2$ | TYP. INTERIOR PLUMBING PARTITION (ONE HOUR - UL# U419) |

ROOM FINISH SCHEDULE - FIRST FLOOR

| USE OF ROOM | FLOOR | BASE | MALLS | CEII | LING | REMARKS |
|-------------|-------|------|----------|----------|----------|---------|
| | 20011 | | | CEILING | CLG. HT. | |
| BATHROOM | HDMD | MB | DW, W/PT | DW, W/PT | 9'-0" | |
| | | | | | | |
| | | | | | | |
| | | | | | | |
| | | | | | | |
| | | | | | | |

<u>ABBREVIATIONS</u>

- GF - Genc. Floer - VT - Vinyl Gemposition -Tile - PT - Paint - GPT - Garpeting - DW - Gypsum Drywall - HDWDHard Wood Flooring - CT - Ceramic Tile - RB - Rubber Base 4" High - WB - Wood Base 6" High REHABILIT

RESIDENTIA


1

DATE ISSUED:
3-18-2016

3-18-2016 PROJECT # 1603

SHEET TITLE:

ARCHITECTURAL PLAN FLOORPLANS, SCHEDULES
& NOTES

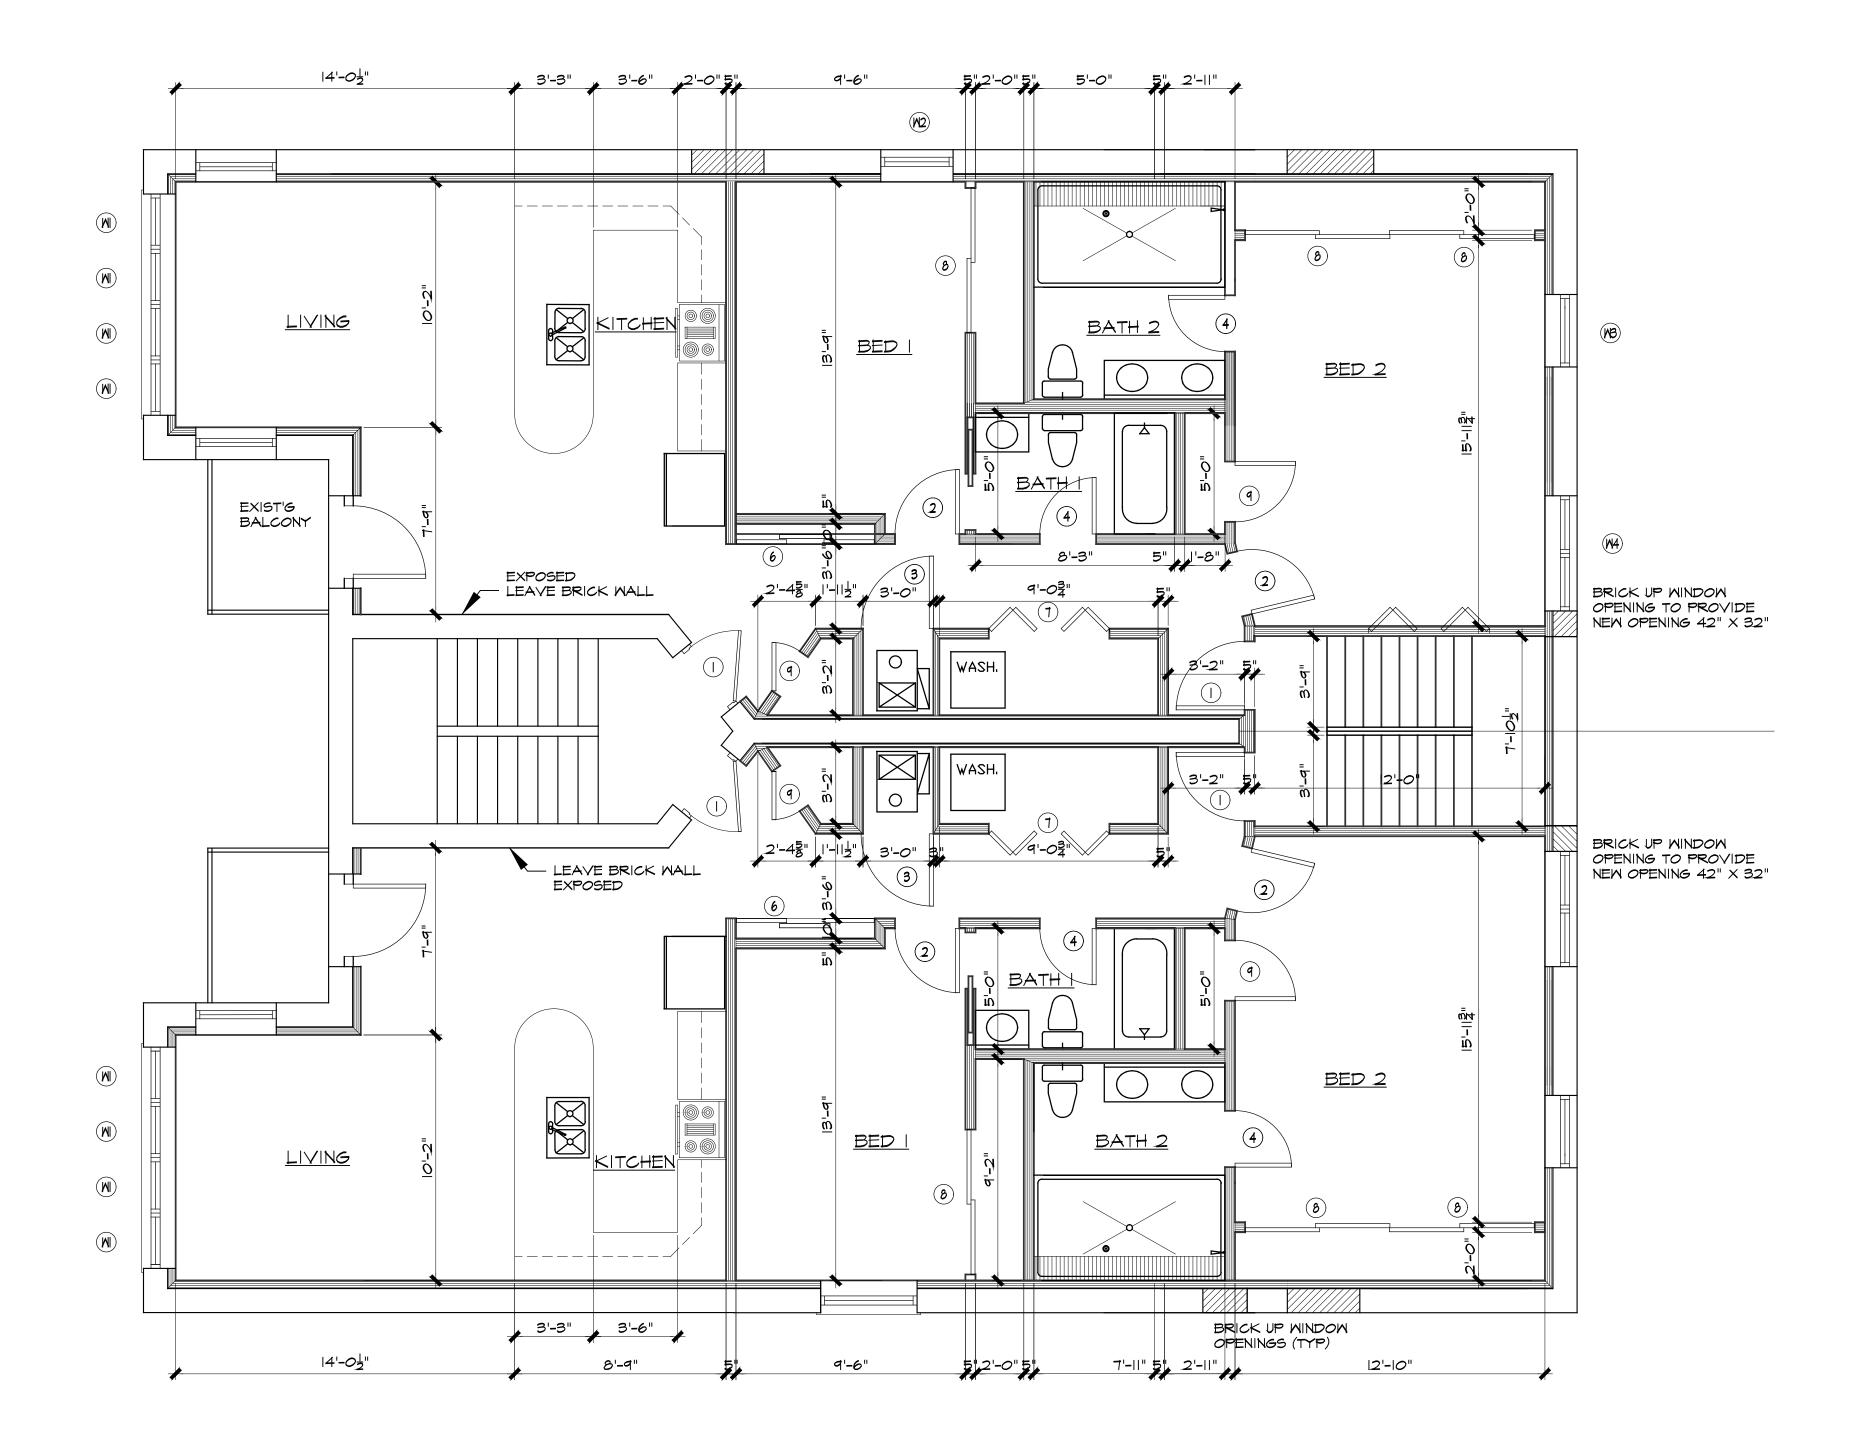

ARCHITECTURAL PLAN = FIRST, SECOND & THIRD FLOORS

SCALE: 1/4" = 1'-0"

ARCHITECTURAL GENERAL NOTES:

- I. ALL INTERIOR FINISHES TO COMPLY WITH SECTION 15-8-420 C.B./15-8-440 C.B.C.
- 2. ALL EXIT DOORS TO REMAIN KEYLESS IN THE DIRECTION OF EGRESS.
- 3. ALL GLASS TO COMPLY WITH SECTION 13-124-350 C.B.C. AND SHALL BE SAFETY GLAZED.
- 4. ALL MATERIALS FOR INTERIOR FINISHES FOR WALLS AND CEILING SHALL NOT BE LESS RESISTANT TO FLAME SPREAD THAN CLASS I.
- 5. ALL FLOOR COVERING SHALL MEET CLASS "A" REQUIREMENTS.
- 6. WATER RESISTANT GYPSUM BACKER BOARD IS REQUIRED AROUND ALL TUB AND SHOWER WALLS.
- 7. PROVIDE TEMPERED GLASS IN ALL PATIO DOORS AND BATHROOM WINDOWS.

<u> MINDOM SCHEDULE</u>

| | | | | | | | 1 |
|------------|----------|---------------|----------|-----------------|-----------------------|----------------------|---------|
| TAG | TYPE | <u>SIZE</u> | <u> </u> | <u>LOCATION</u> | <u>LIGHT</u> (SF.) | <u>VENT</u> (SF.) | REMARKS |
| | CASEMENT | 2'-2" X 5'-4" | 24 | LIVING ROOM | .6 | 11.6 | |
| W2 | CASEMENT | 3'-0" × 4'-8" | w | BED * | 14.7 | 14.7 | |
| (MB) | CASEMENT | 3'-0" × 4'-9" | 0 | BED 2 | 14.3 | 14.3 | |
| W4) | CASEMENT | 5'-I" × 4'-9" | 0 | BED 2 | 24.3 | .24.3 | |
| % 5 | CASEMENT | 4'-0" × 4'-6" | 2 | BED ** | 18.7 | 18.7 | |

* - BED I IN WEST UNIT ** - BED I IN EAST UNIT

DOOR SCHEDULE

| TAG | TYPE | SIZE | <u> </u> | <u>LOCATION</u> | HARDWARE | FRAME | REMARKS |
|----------|---------|---------------|----------|------------------|----------|-------|---------|
| | SMING | 3'-0" × 7'-0" | 4 | ALL ENTRY POINTS | I | WD. | |
| 2 | SMING | 2'-8" × 7'-0" | 4 | BEDROOMS | 2 | Ø. | |
| (3) | SMING | 3'-0" × 7'-0" | 2 | UTILTY | 3 | ₽. | |
| 4 | SMING | 2'-4" × 7'-0" | 4 | BATHROOMS | 4 | Ø. | |
| 5 | SLIDING | 4'-0" × 7'-0" | 2 | CLOSETS | 2 | Ø. | |
| 6 | SLIDING | 5'-9" × 7'-0" | 2 | PANTRY | 2 | ₽. | |
| 7 | BI-FOLD | 5'-0" × 7'-0" | 2 | LAUNDRY | 2 | Ø. | |
| 8 | SLIDING | 6'-0" × 7'-0" | 6 | CLOSET | 2 | Ď. | |
| (| SLIDING | 2'-6" × 7'-0" | 4 | CLOSET | 2 | WD. | |


HARDWARE SCHEDULE

| 17 11 12 1 | , | |
|-------------|-----------------|---|
| <u>MARK</u> | <u>FUNCTION</u> | <u>REMARKS</u> |
| I | BUILDING ENTRY | ENTRY LOCKSET, DOOR STOP & WEATHERSTRIPPING |
| 2 | PRIVACY | PRIVACY LOCKSET, DOOR STOP |
| 3 | PASSAGE | PASSAGE LOCKSET, DOOR STOP |
| 4 | CLOSET | DUMMY KNOB, DOOR STOP |

MALL LEGEND:



MALL TYPE SCHEDULE: N.T.S.

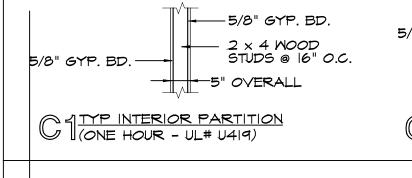

| 5/8" GYP. BD. | 5/8" GYP. BD. 2 × 6 WOOD 5TUDS @ 16" O.C. |
|------------------|---|
| | 7" OVERALL |
| TYP. INTERIOR | R PLUMBING PARTITIO |
| GZ (ONE HOUR - L | R PLUMBING PARTITIC JL# U419) |

ROOM FINISH SCHEDULE - FIRST FLOOR

| USE OF ROOM | FLOOR | BASE | WALLS | CEILING | CLG. HT. | REMARKS |
|-------------|-------|------|----------|----------|----------|---------|
| BATHROOM | HDMD | ß | DW, W/PT | DW, W/PT | 9'-0" | |
| | | | | | | |
| | | | | | | |
| | | | | | | |
| | | | | | | |
| | | | | | | |
| | | | | | | |

ABBREVIATIONS


-VT Vinyl Composition Tile DW Gypsum Drywall CT Ceramic Tile RB Rubber Base 4" High

HDWDHard Wood Flooring WB Wood Base 6" High

1

REHABILIT


RESIDENTIA

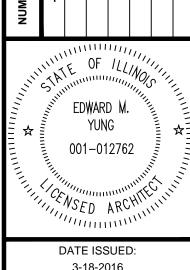



3-18-2016 PROJECT # 1603

SHEET TITLE: ARCHITECTURAL PLAN -FLOORPLANS, SCHEDULES & NOTES



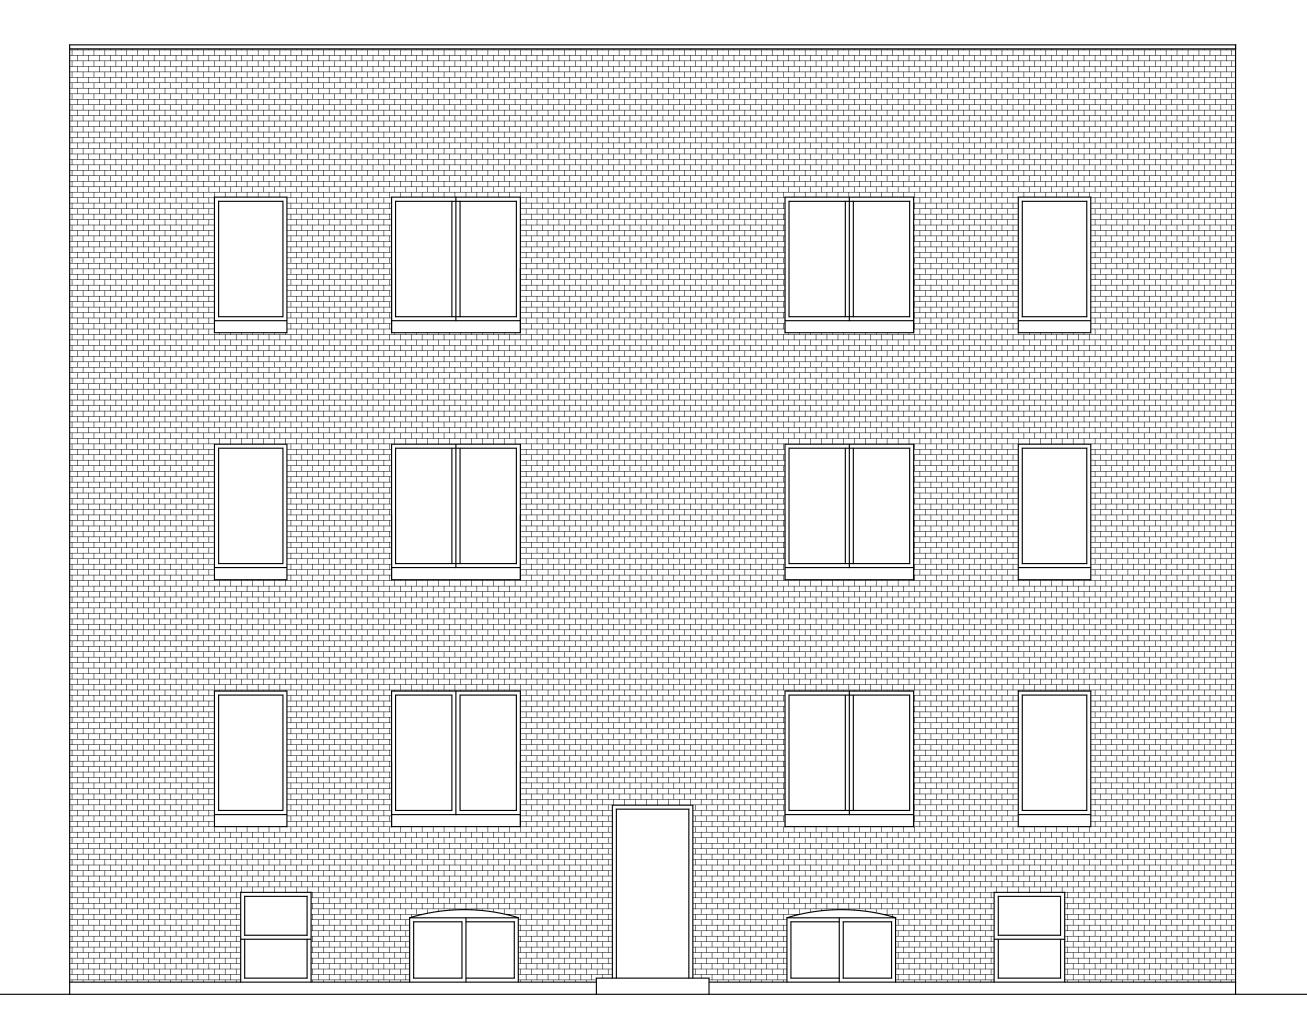

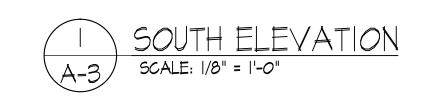

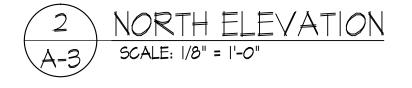

YUNG Architects/planners/interiors/construction managers

DENTIAL REHABILITATION

350 EAST 50TH STREET

CHICAGO, ILLINOIS

RESIDENTIA 350 EA


PATE ISSUED:


DATE ISSUED: 3-18-2016

PROJECT # 1603

SHEET TITLE:

ARCHITECTURAL PLAN FLOORPLANS, SCHEDULES
& NOTES

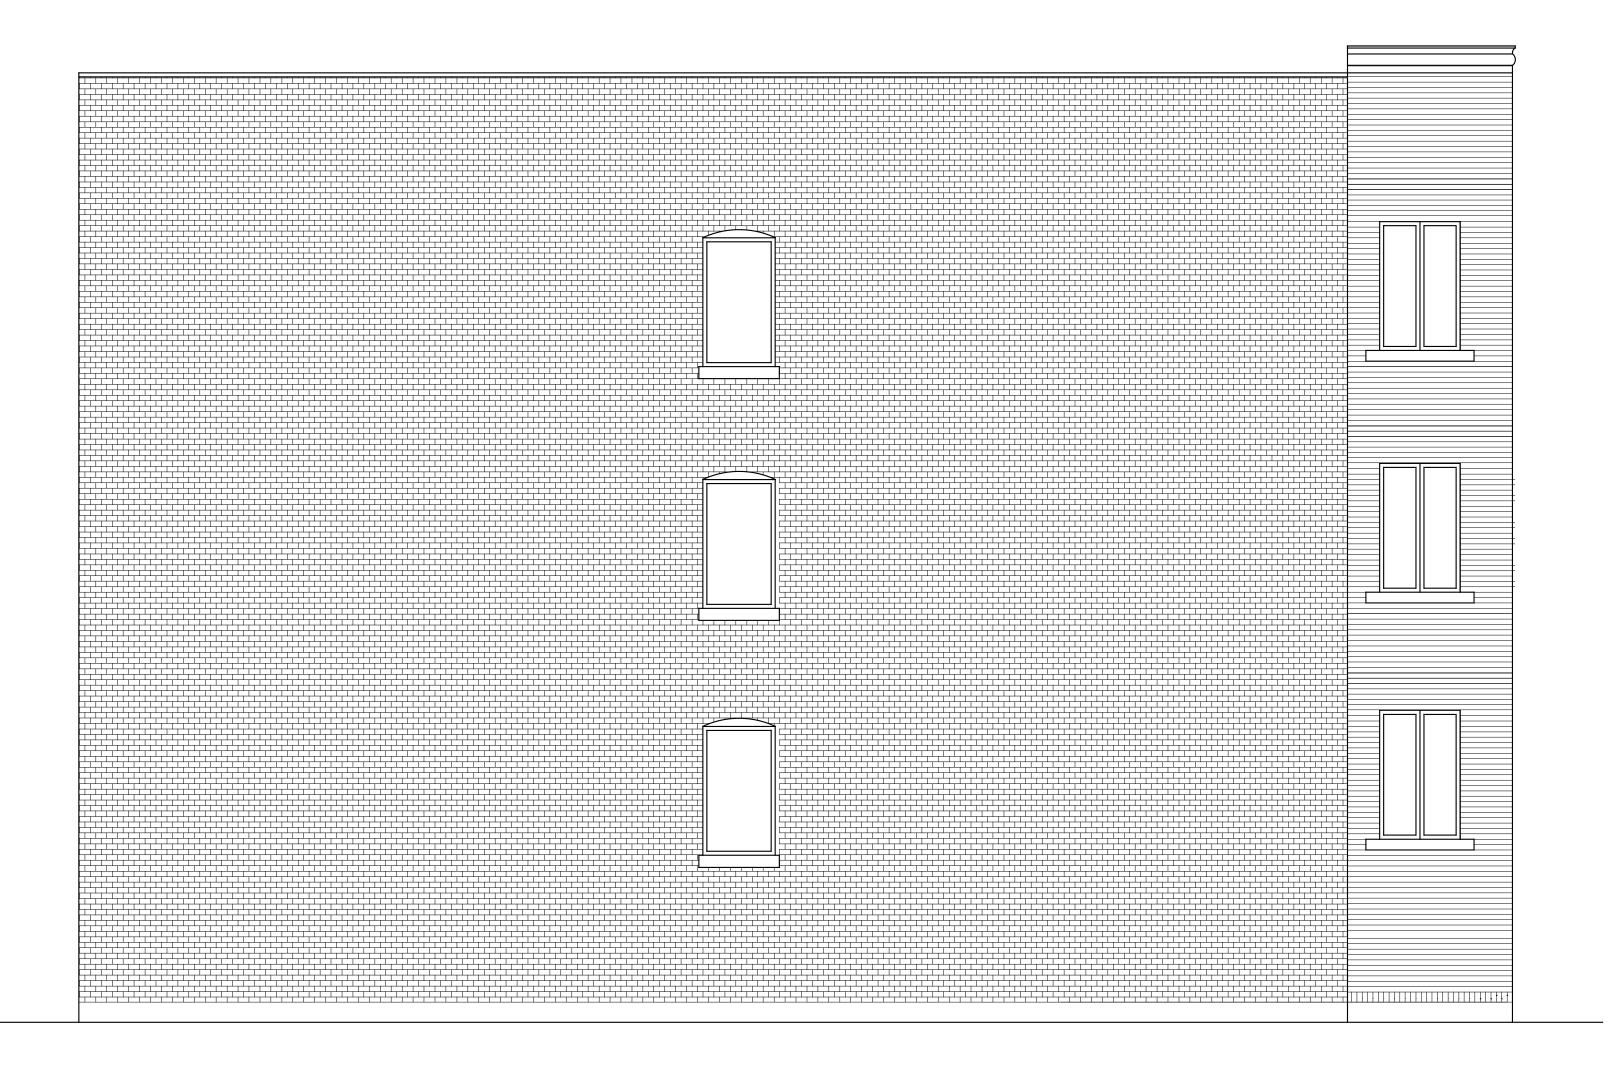

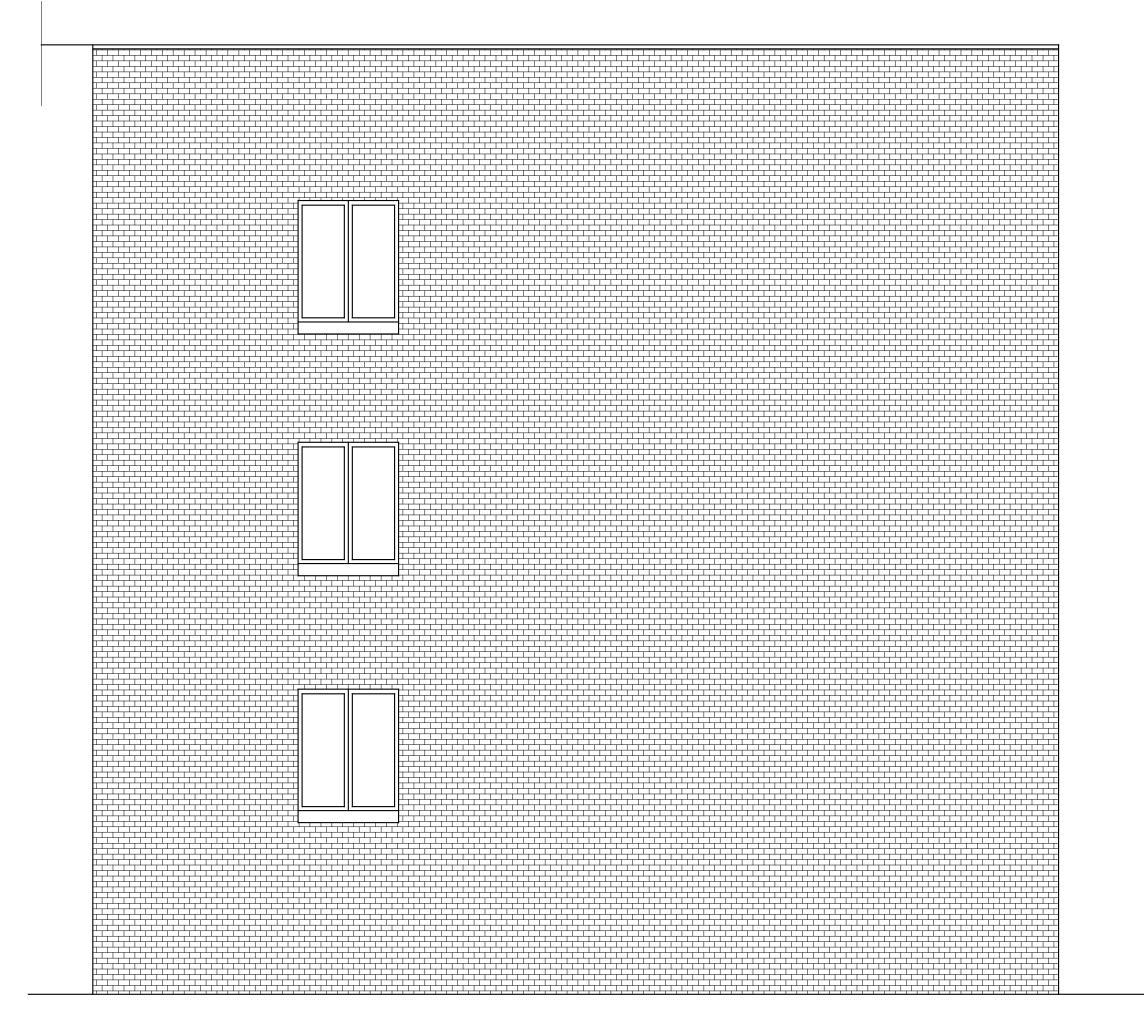






L REHABILITATION RESIDENTIA


EDWARD M. YUNG

DATE ISSUED: 3-18-2016

PROJECT # 1603 SHEET TITLE: ELECTRICAL PLAN -PLANS, SCHEDULES, & NOTES

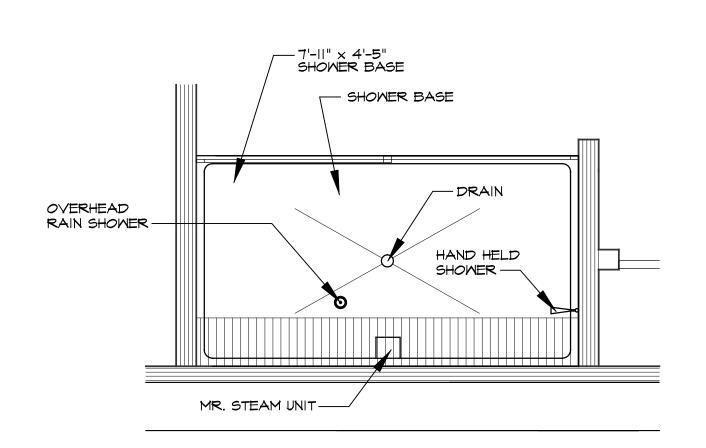



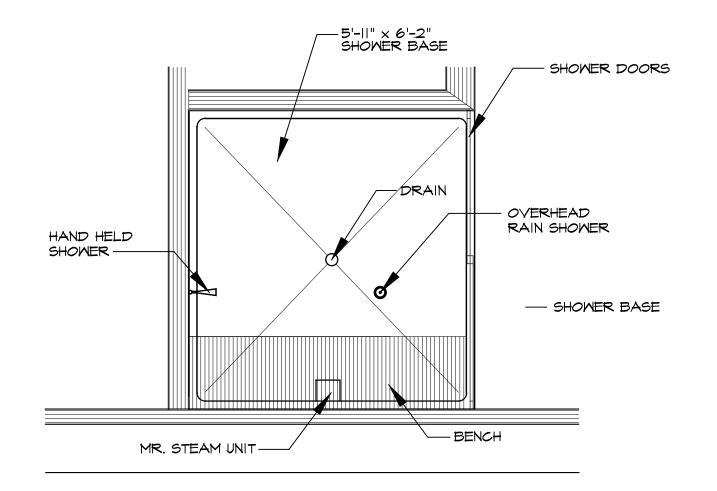

ENLARGED EAST STEAM ROOM (BASEMENT)

SCALE: 1/2" = 1'-0"

YUNG Architects/planners/interiors/construction managers

L REHABILITATION

NUMBER REVISIONS DATE

- - RESIDENTIA
350 EA
350 EA

EDWARD M.

YUNG

OO1-012762


DATE ISSUED 3-18-2016


PROJECT # 1603


SHEET TITLE:

MECHANICAL PLAN PLANS, SCHEDULES
& NOTES

_{ЕЕТ#:}

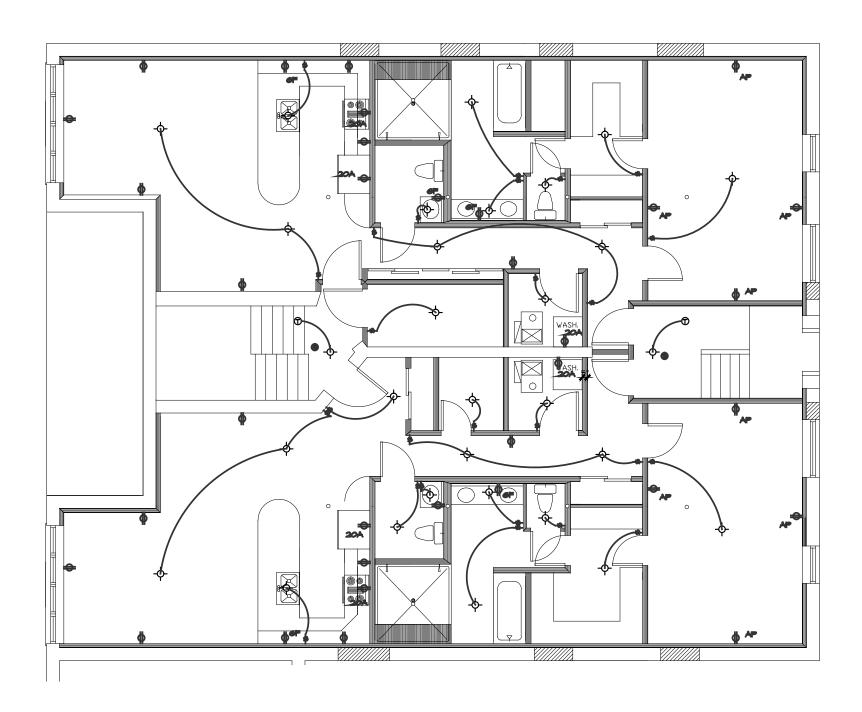

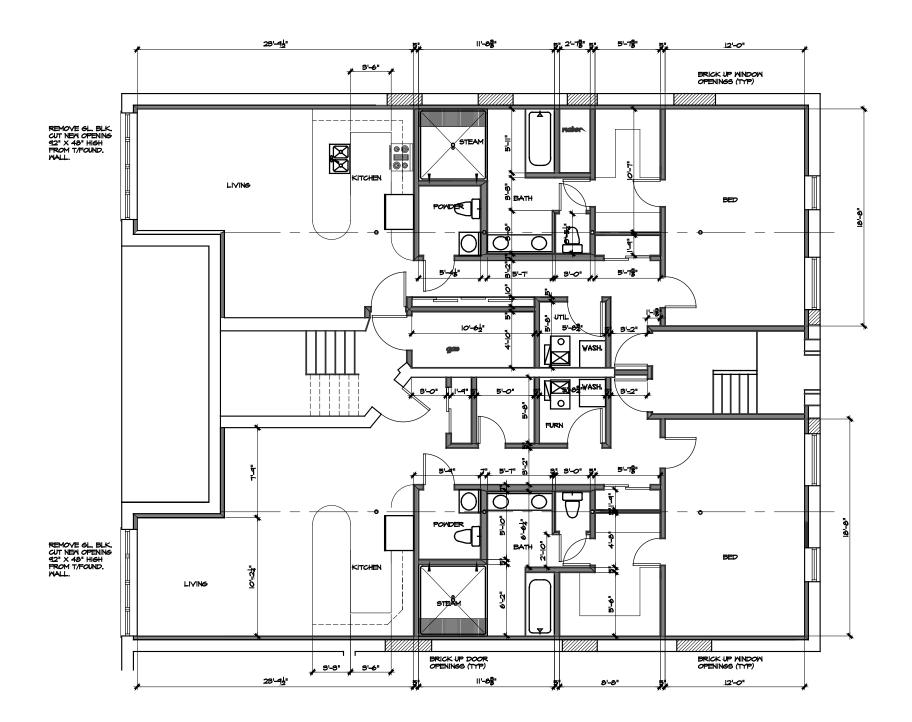

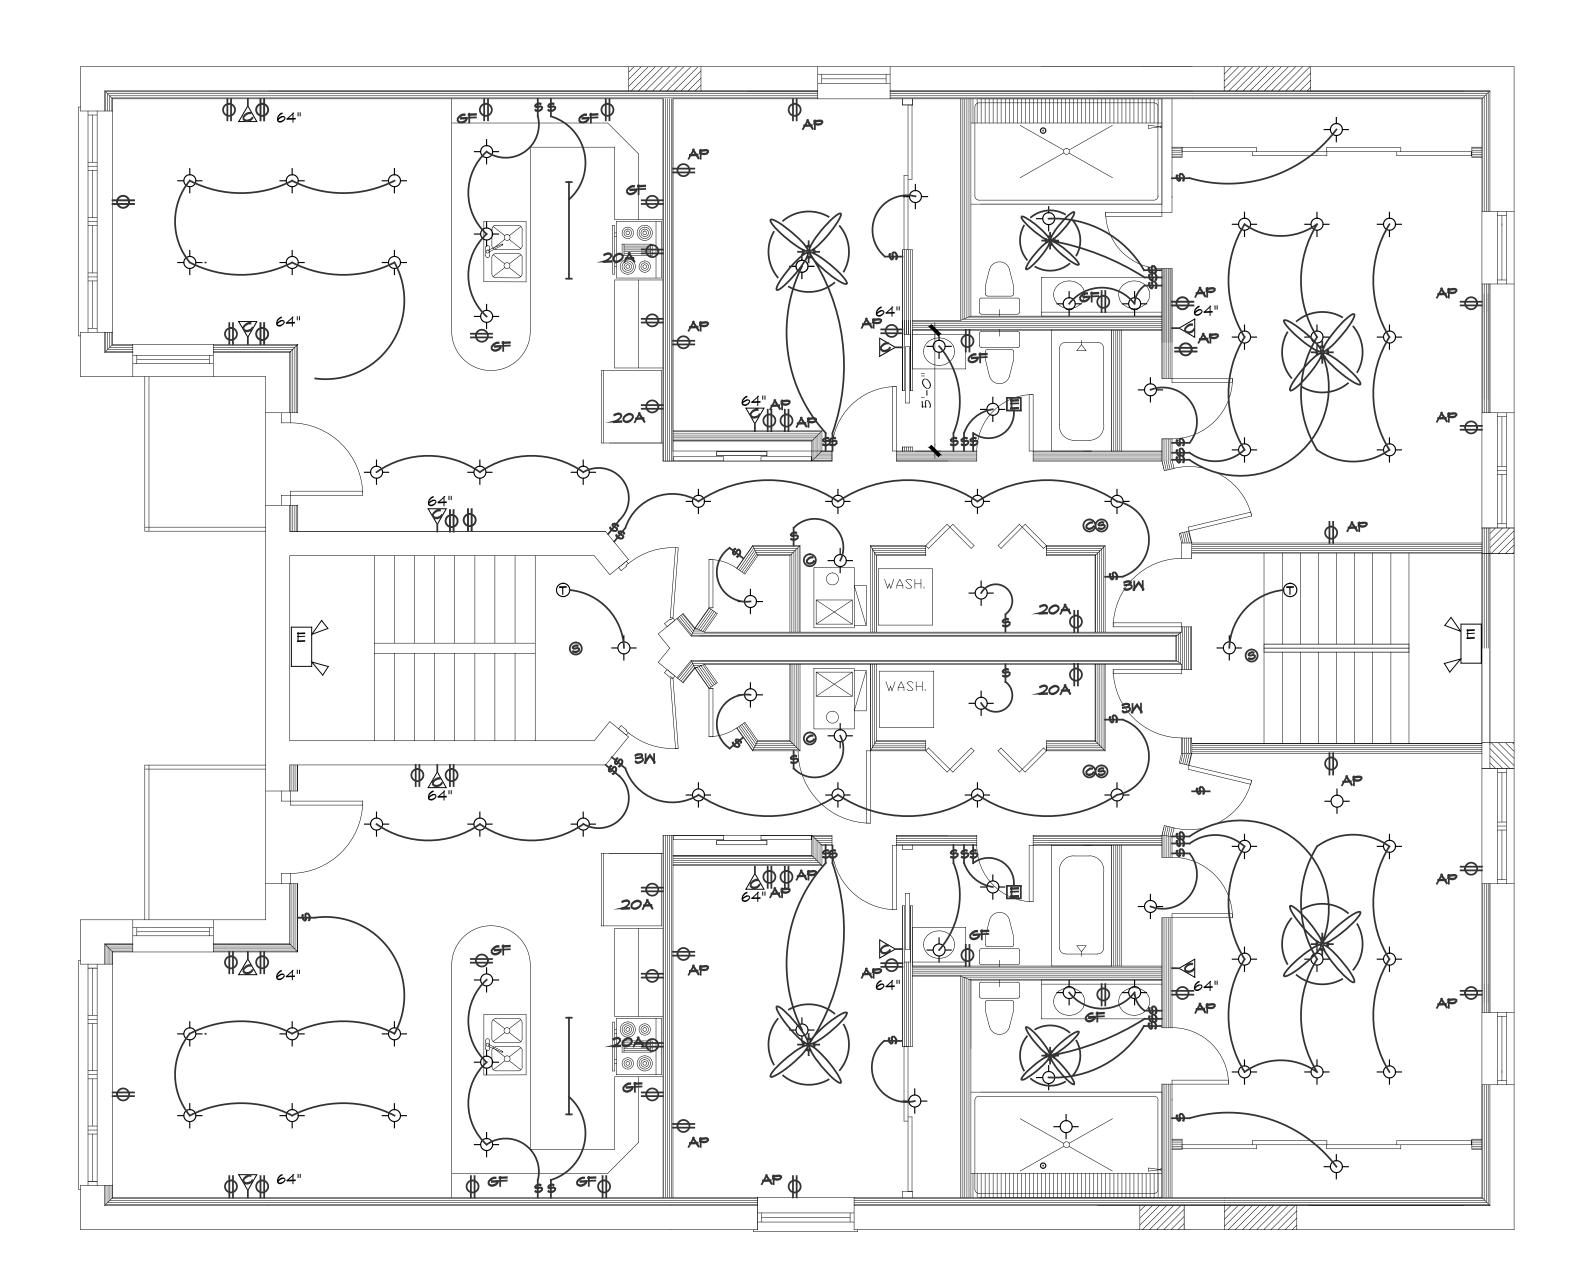

2 ELECTRICAL PLAN = FIRST TO THIRD FLOORS
E-2 SCALE: 1/4" = 1'-0"

ELECTRICAL LEGEND

SMOKE DETECTOR HARD WIRED - 110 V. BATTERY BACKUP

CARBON MONOXIDE DETECTOR

DUPLEX OUTLET

DUPLEX OUTLET W/ GROUND FAULT INTERRUPTER

DUPLEX OUTLET W/ 20 AMP

DUPLEX OUTLET W/ ARC PROTECTION

LIGHT SWITCH

3-MAY LIGHT SMITCH

E EXHAUST FAN

ELECTRICAL PANEL

CEILING FAN

ELECTRICAL NOTES:

- I. THIS CONTRACTOR SHALL VISIT THE SITE AND BE FAMILIAR WITH THE JOB CONDITION PRIOR TO SUBMITTING THE BID.
- 2. THIS CONTRACTOR SHALL PAY FOR ALL THE TAXES AND FEES AND GIVE LOCAL AUTHORITIES ALL NOTICES RELATING TO HIS WORK.
- 3. WORKMANSHIP SHALL BE DONE IN A FIRST CLASS MANNER.
- 4. ALL MATERIALS USED FOR THIS JOB SHALL BE NEW AND THE BEST OF THEIR KIND.
- 5. ALL WORK SHALL BE DONE IN ACCORDANCE WITH ALL STATE AND LOCAL CODES.
- 6. THIS CONTRACTOR SHALL GUARANTEE ALL WORK AND MATERIAL FOR ONE YEAR AFTER COMPLETION AGAINST ALL DEFECTS OF MATERIAL, EQUIPMENT AND WORKMANSHIP.
- 7. THIS CONTRACTOR TO TEST SYSTEM PRIOR TO OPERATION.
- 8. UNLESS OTHERWISE NOTED, DISCONNECT AND REMOVE EXISTING ITEMS SUCH AS LIGHTING FIXTURES, OUTLETS, ETC. THAT ARE RENDERED OBSOLETE DUE TO THE ALTERATIONS AND/OR ADDITION. REMOVE ASSOCIATED WIRING AND EXPOSED CONDUIT, CAP AND ABANDON CONCEALED CONDUIT.
- 9. ELECTRICAL CONTRACTOR SHALL REMOVE ALL EXISTING RECEPTACLES, CONDUIT, LIGHTING FIXTURES AND DEVICES IN AREAS WHERE CEILING, WALLS, FLOORS OR PARTITIONS ARE RE-WORKED OR REMOVED. THE CONTRACTOR SHALL TAKE ADEQUATE CARE AND CAUTION AS NOT TO DAMAGE ADJACENT SURFACES.
- IO INSTALL NEW SWITCHES AND GROUNDING-TYPE RECEPTACLES. INSTALL NEW CONDUIT AND WIRING TO ALL NEW FIXTURES, SWITCHES AND RECEPTACLES.
- II. INSTALL NEW LIGHT FIXTURES AND CEILING FANS. LIGHT FIXTURES AND CEILING FANS TO BE SUPPLIED BY THE OWNER.
- 12. SWITCHES, RECEPTACLES, TELEPHONE OUTLETS, ETC. SHALL NOT BE INSTALLED BACK TO BACK. ALL RECEPTACLES AND TELEPHONE OUTLETS TO BE INSTALLED 1'-O" A.F.F. UNLESS NOTED, SWITCHES 54" A.F.F.
- 13. CONDUIT RUNS SHOWN ON THE DRAWINGS ARE DIAGRAMMATIC. ACTUAL FIELD CONDITIONS SHOULD BE FOLLOWED.
- 14. WHERE AS A RESULT OF CHANNELING THROUGH OF A CONDUIT, EXISTING PLASTER WALLS ARE MARRED, THE ELECTRICAL CONTRACTOR SHALL BE RESPONSIBLE FOR THEIR REPAIR. HE SHALL PATCH SUCH AREAS TO A DEGREE OF FINISH AS TO BE PAINTABLE BY ACCEPTABLE STANDARDS OF THE DAY.
- 15. ALL SYSTEMS SHALL BE COMPLETE AND OPERATING, PROVIDE ALL MATERIALS, CONDUIT WIRING, JUNCTION BOXES, ETC. AS REQUIRED.
- 16. ALL FIXTURES SHALL BE INSTALLED AT THE HEIGHT NOTED IN THE LIGHTING SCHEDULE.
- 17. APPROVED TYPE CEILING BOXES ARE REQUIRED FOR PADDLE FAN NOT IN EXCESS OF 35 POUNDS.
- 18. CLOSET LIGHTS SHALL OF THE FOLLOWING CLEARANCE FROM SHELVES AND HAVE A GLOBE OVER IT:
 - 18.1. FLUORESCENT FIXTURES SHALL HAVE A 6" SPACE FROM THE EDGE OF THE SHELF.
 - 18.2. INCANDESCENT FIXTURES SHALL HAVE A 12" SPACE FROM THE EDGE OF THE SHELF.
- 19. ALL OUTLETS TO BE MOUNTED ABOVE COUNTERTOP IN KITCHEN.
- 20. ALL ELECTRICAL OUTLETS WITHIN 6'-O" OF ANY SINK OR WATER SOURCE SHALL BE GROUND FAULT PROTECTED.
- 21. ALL ELECTRICAL OUTLETS IN SLEEPING ROOMS & BEDROOMS SHALL BE "ARC-FAULT" PROTECTED.
- 22. ALL ELECTRICAL WORK SHALL COMPLY WITH THE CITY OF CHICAGO BUILDING CODES.

UING Architects illings 60067

TIAL REHABILITATION
50 EAST 50TH STREET
CHICAGO ILLINOIS

RESIDENTIAL I

EDWARD M.

YUNG

WARD M.

THE STATE OF ILLINOIS INTERPRETATION OF ILLINOIS


DATE ISSUED: 3-18-2016

PROJECT # 1603

SHEET TITLE:

ELECTRICAL PLAN PLANS, SCHEDULES, & NOTES

SHEET #:

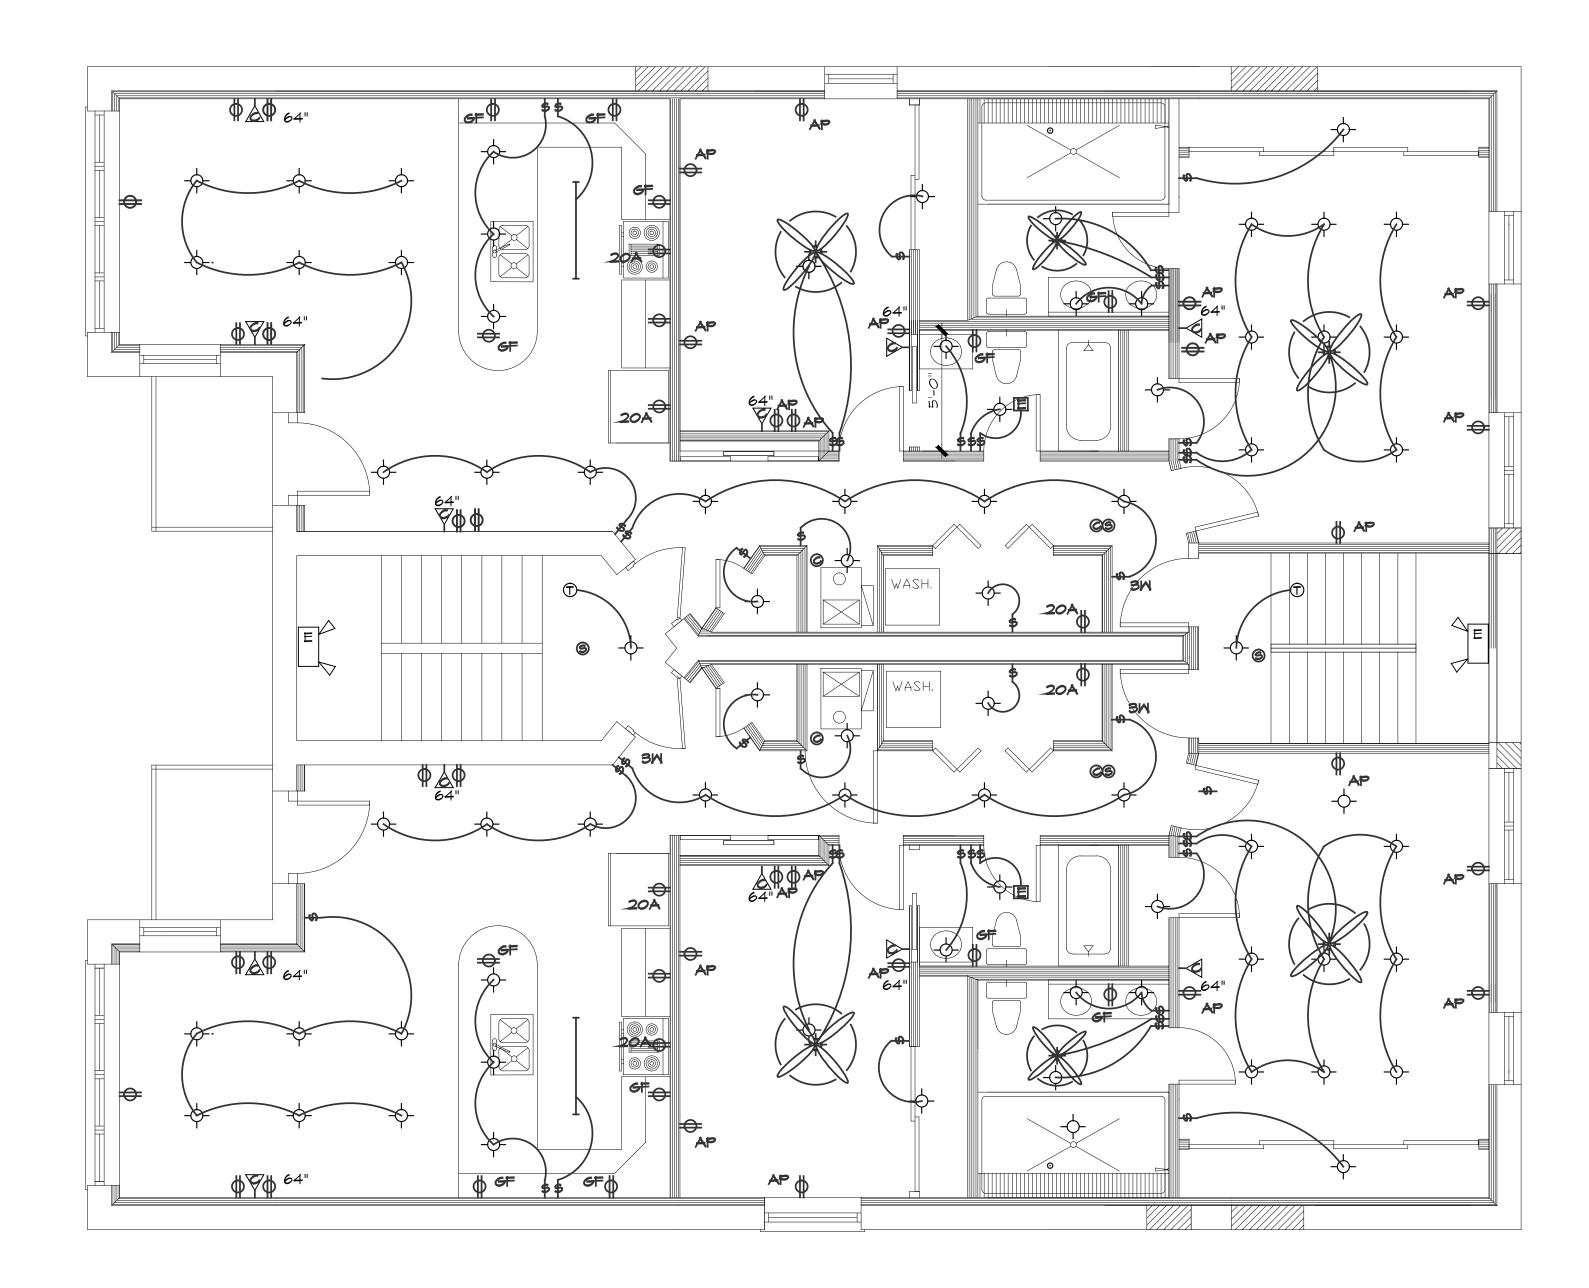

2 ELECTRICAL PLAN - FIRST TO THIRD FLOORS
E-2 SCALE: 1/4" = 1'-0"

ELECTRICAL LEGEND

SMOKE DETECTOR HARD WIRED - 110 V. BATTERY BACKUP

CARBON MONOXIDE DETECTOR

DUPLEX OUTLET

DUPLEX OUTLET W/ GROUND FAULT INTERRUPTER

20A DUPLEX OUTLET W/ 20 AMP

MAP DUPLEX OUTLET W/ ARC PROTECTION

LIGHT SWITCH

3-MAY LIGHT SMITCH

E EXHAUST FAN

ELECTRICAL PANEL

CEILING FAN

ELECTRICAL NOTES:

- I. THIS CONTRACTOR SHALL VISIT THE SITE AND BE FAMILIAR WITH THE JOB CONDITION PRIOR TO SUBMITTING THE BID.
- 2. THIS CONTRACTOR SHALL PAY FOR ALL THE TAXES AND FEES AND GIVE LOCAL AUTHORITIES ALL NOTICES RELATING TO HIS WORK.
- 3. WORKMANSHIP SHALL BE DONE IN A FIRST CLASS MANNER.
- 4. ALL MATERIALS USED FOR THIS JOB SHALL BE NEW AND THE BEST OF THEIR KIND.
- 5. ALL WORK SHALL BE DONE IN ACCORDANCE WITH ALL STATE AND LOCAL CODES.
- 6. THIS CONTRACTOR SHALL GUARANTEE ALL WORK AND MATERIAL FOR ONE YEAR AFTER COMPLETION AGAINST ALL DEFECTS OF MATERIAL, EQUIPMENT AND WORKMANSHIP.
- 7. THIS CONTRACTOR TO TEST SYSTEM PRIOR TO OPERATION.
- 8. UNLESS OTHERWISE NOTED, DISCONNECT AND REMOVE EXISTING ITEMS SUCH AS LIGHTING FIXTURES, OUTLETS, ETC. THAT ARE RENDERED OBSOLETE DUE TO THE ALTERATIONS AND/OR ADDITION. REMOVE ASSOCIATED WIRING AND EXPOSED CONDUIT, CAP AND ABANDON CONCEALED CONDUIT.
- 9. ELECTRICAL CONTRACTOR SHALL REMOVE ALL EXISTING RECEPTACLES, CONDUIT, LIGHTING FIXTURES AND DEVICES IN AREAS WHERE CEILING, WALLS, FLOORS OR PARTITIONS ARE RE-WORKED OR REMOVED. THE CONTRACTOR SHALL TAKE ADEQUATE CARE AND CAUTION AS NOT TO DAMAGE ADJACENT SURFACES.
- IO INSTALL NEW SMITCHES AND GROUNDING-TYPE RECEPTACLES. INSTALL NEW CONDUIT AND WIRING TO ALL NEW FIXTURES, SMITCHES AND RECEPTACLES.
- II. INSTALL NEW LIGHT FIXTURES AND CEILING FANS. LIGHT FIXTURES AND CEILING FANS TO BE SUPPLIED BY THE OWNER.
- 12. SWITCHES, RECEPTACLES, TELEPHONE OUTLETS, ETC. SHALL NOT BE INSTALLED BACK TO BACK. ALL RECEPTACLES AND TELEPHONE OUTLETS TO BE INSTALLED 1'-O" A.F.F. UNLESS NOTED, SWITCHES 54" A.F.F.
- 13. CONDUIT RUNS SHOWN ON THE DRAWINGS ARE DIAGRAMMATIC. ACTUAL FIELD CONDITIONS SHOULD BE FOLLOWED.
- 14. WHERE AS A RESULT OF CHANNELING THROUGH OF A CONDUIT, EXISTING PLASTER WALLS ARE MARRED, THE ELECTRICAL CONTRACTOR SHALL BE RESPONSIBLE FOR THEIR REPAIR. HE SHALL PATCH SUCH AREAS TO A DEGREE OF FINISH AS TO BE PAINTABLE BY ACCEPTABLE STANDARDS OF THE DAY.
- 15. ALL SYSTEMS SHALL BE COMPLETE AND OPERATING, PROVIDE ALL MATERIALS, CONDUIT WIRING, JUNCTION BOXES, ETC. AS REQUIRED.
- 16. ALL FIXTURES SHALL BE INSTALLED AT THE HEIGHT NOTED IN THE LIGHTING SCHEDULE.
- 17. APPROVED TYPE CEILING BOXES ARE REQUIRED FOR PADDLE FAN NOT IN EXCESS OF 35 POUNDS.
- 18. CLOSET LIGHTS SHALL OF THE FOLLOWING CLEARANCE FROM SHELVES AND HAVE A GLOBE OVER IT:
 - 18.1. FLUORESCENT FIXTURES SHALL HAVE A 6" SPACE FROM THE EDGE OF THE SHELF.
 - 1962. INCANDESCENT FIXTURES SHALL HAVE A 12" SPACE FROM THE EDGE OF THE SHELF.
- 19. ALL OUTLETS TO BE MOUNTED ABOVE COUNTERTOP IN KITCHEN.
- 20. ALL ELECTRICAL OUTLETS WITHIN 6'-O" OF ANY SINK OR WATER SOURCE SHALL BE GROUND FAULT PROTECTED.
- 21. ALL ELECTRICAL OUTLETS IN SLEEPING ROOMS & BEDROOMS SHALL BE "ARC-FAULT" PROTECTED.
- 22. ALL ELECTRICAL WORK SHALL COMPLY WITH THE CITY OF CHICAGO BUILDING CODES.

UINCINECTS Architects manager 10 south roberts road, inverness, illinois 60067

ESIDENTIAL REHABILITATION
350 EAST 50TH STREET

BER REVISIONS DATE

DATE ISSUED: 3-18-2016

PROJECT # 1603

SHEET TITLE:


ELECTRICAL PLAN PLANS, SCHEDULES, & NOTES

SHEET #:

| PANELBOARD | SCHI | <u> </u> | JLE | _ | PN | L— | | ,,, | |
|------------------------|--------|----------|-----|----|----|---------|-----|--------|----------------------------|
| LOAD | VA | P | A | C | СТ | А | Р | VA | LOAD |
| A / | 2145 | 2/ | 30 | 1 | 2 | 15 | | 600 | KITCHEN LT. |
| /c | 2 45 | | | 3 | 4 | 15 | I | 225 | HALLMAY LT. |
| FURNACE | 588 | | 15 | 5 | 6 | <u></u> | | 540 | HALLWAY OUTLETS |
| REFRIGERATOR | 1176 | | 20 | 7 | 8 | <u></u> | | 875 | BEDRM-I & 2, BATH-I & 2 LT |
| KITCHEN OUTLETS | 1500 | | 20 | 9 | 10 | 15 | | 240 | BATH-I \$ 2 EXHAUST |
| KITCHEN OUTLETS | 1500 | | 20 | 11 | 12 | 5 | | 294 | BED RM-I CEILING PAN |
| LIVING/DINING LT | 825 | | 20 | 13 | 14 | 15 | | 294 | BED RM-2 CEILING PAN |
| LIVING/DINING OUTLETS | 540 | | 15 | 15 | 16 | 15 | | 75 | BALCONY LT |
| П | 720 | | 15 | 17 | 18 | | | | |
| | | | | 19 | 20 | | | | |
| | | | | 21 | 22 | | | | |
| | | | | 23 | 24 | | | | |
| | | | | 25 | 26 | | | | |
| | | | | 27 | 28 | | | | |
| | | | | 29 | 30 | | | | |
| | | | | 31 | 32 | | | | |
| | | | | 33 | 34 | | | | |
| | | | | 35 | 36 | | | | |
| | | | | | 38 | | | | |
| | | | | | 40 | | | | |
| | | | | | 42 | | | | |
| TOTAL LOAD : 4282 | VA. 60 | A | | l | | | BAL | _ANCED | LOAD : 6830 VA |
| SERVICE : 120 / 240 V, | | | | | | | = | | MAINS: 100 A, C.B. |

TYP. PANEL SCHEDULE (TYPE-B, -CI, -C2)

SCALE: N.T.S

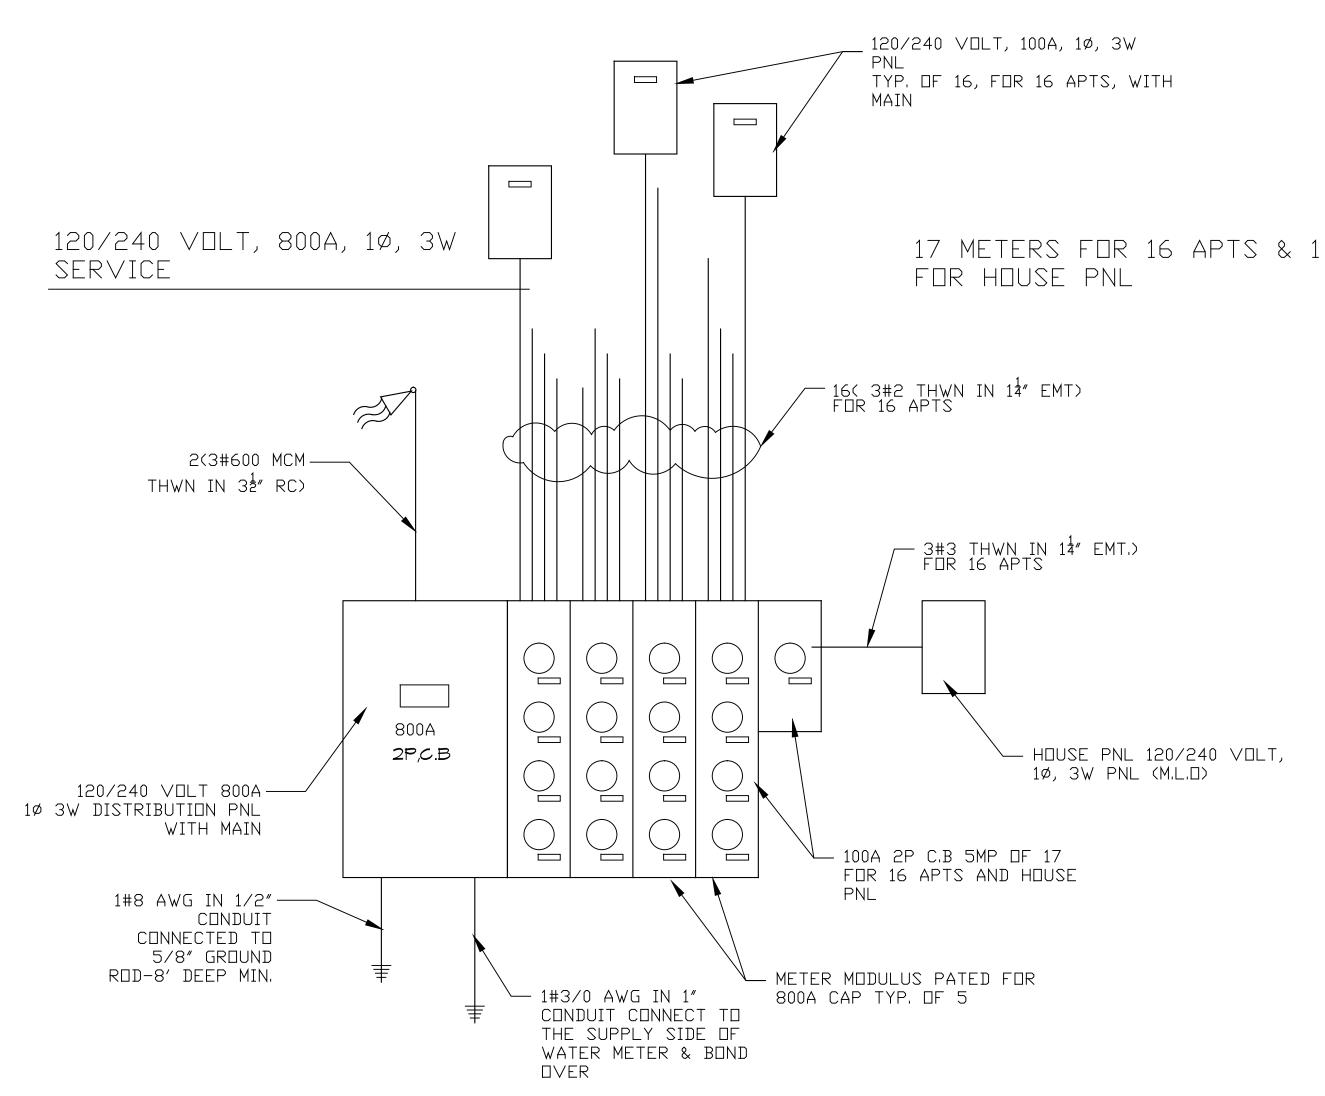

I-LINE ELECTRICAL RISER DIAGRAM
SCALE: NTS

YUNG Architects/planners/interiors/construction managers

RESIDENTIAL REHABILITATION
350 EAST 50TH STREET

NUMBER REVISIONS DATE

EDWARD M.

YUNG

OO1-012762


DATE ISSUED: 3-18-2016 PROJECT # 1603


SHEET TITLE:


ELECTRICAL PLAN PLANS, SCHEDULES, & NOTES


SHEET #:



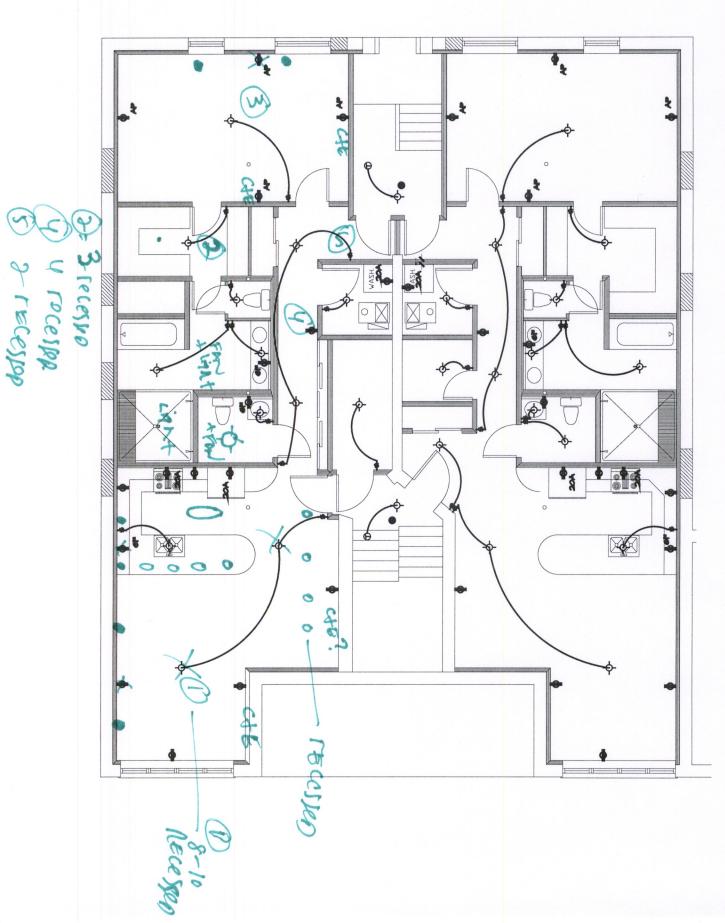

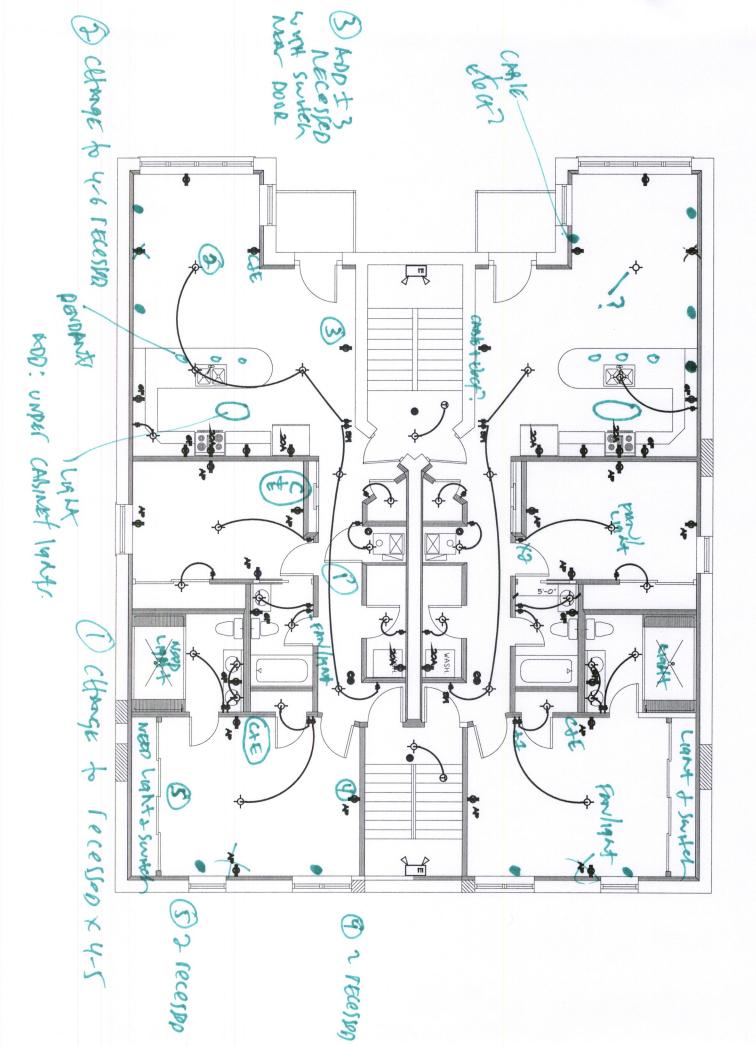

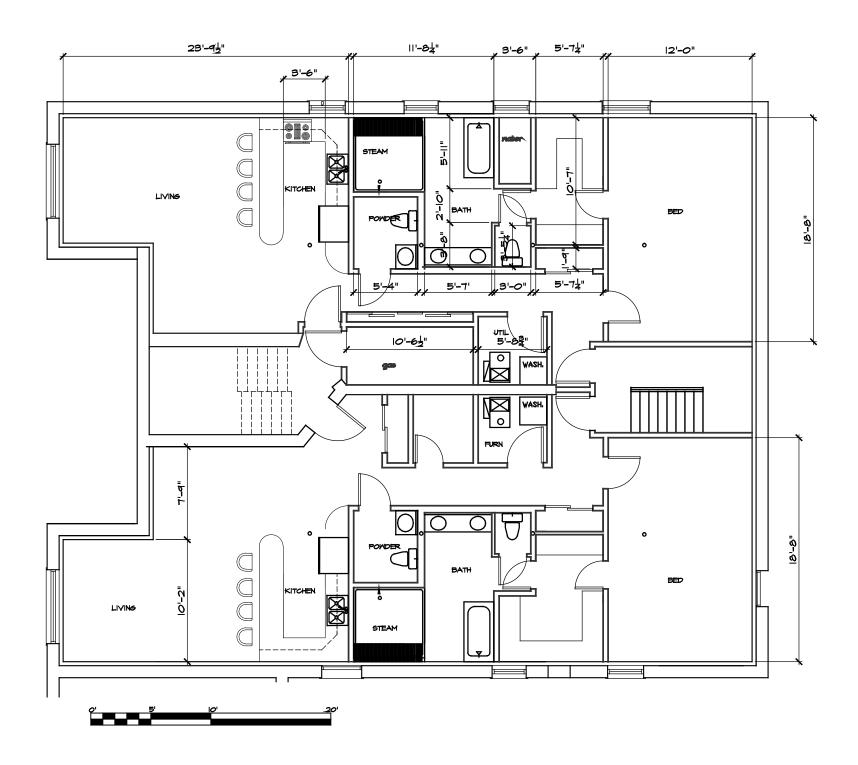

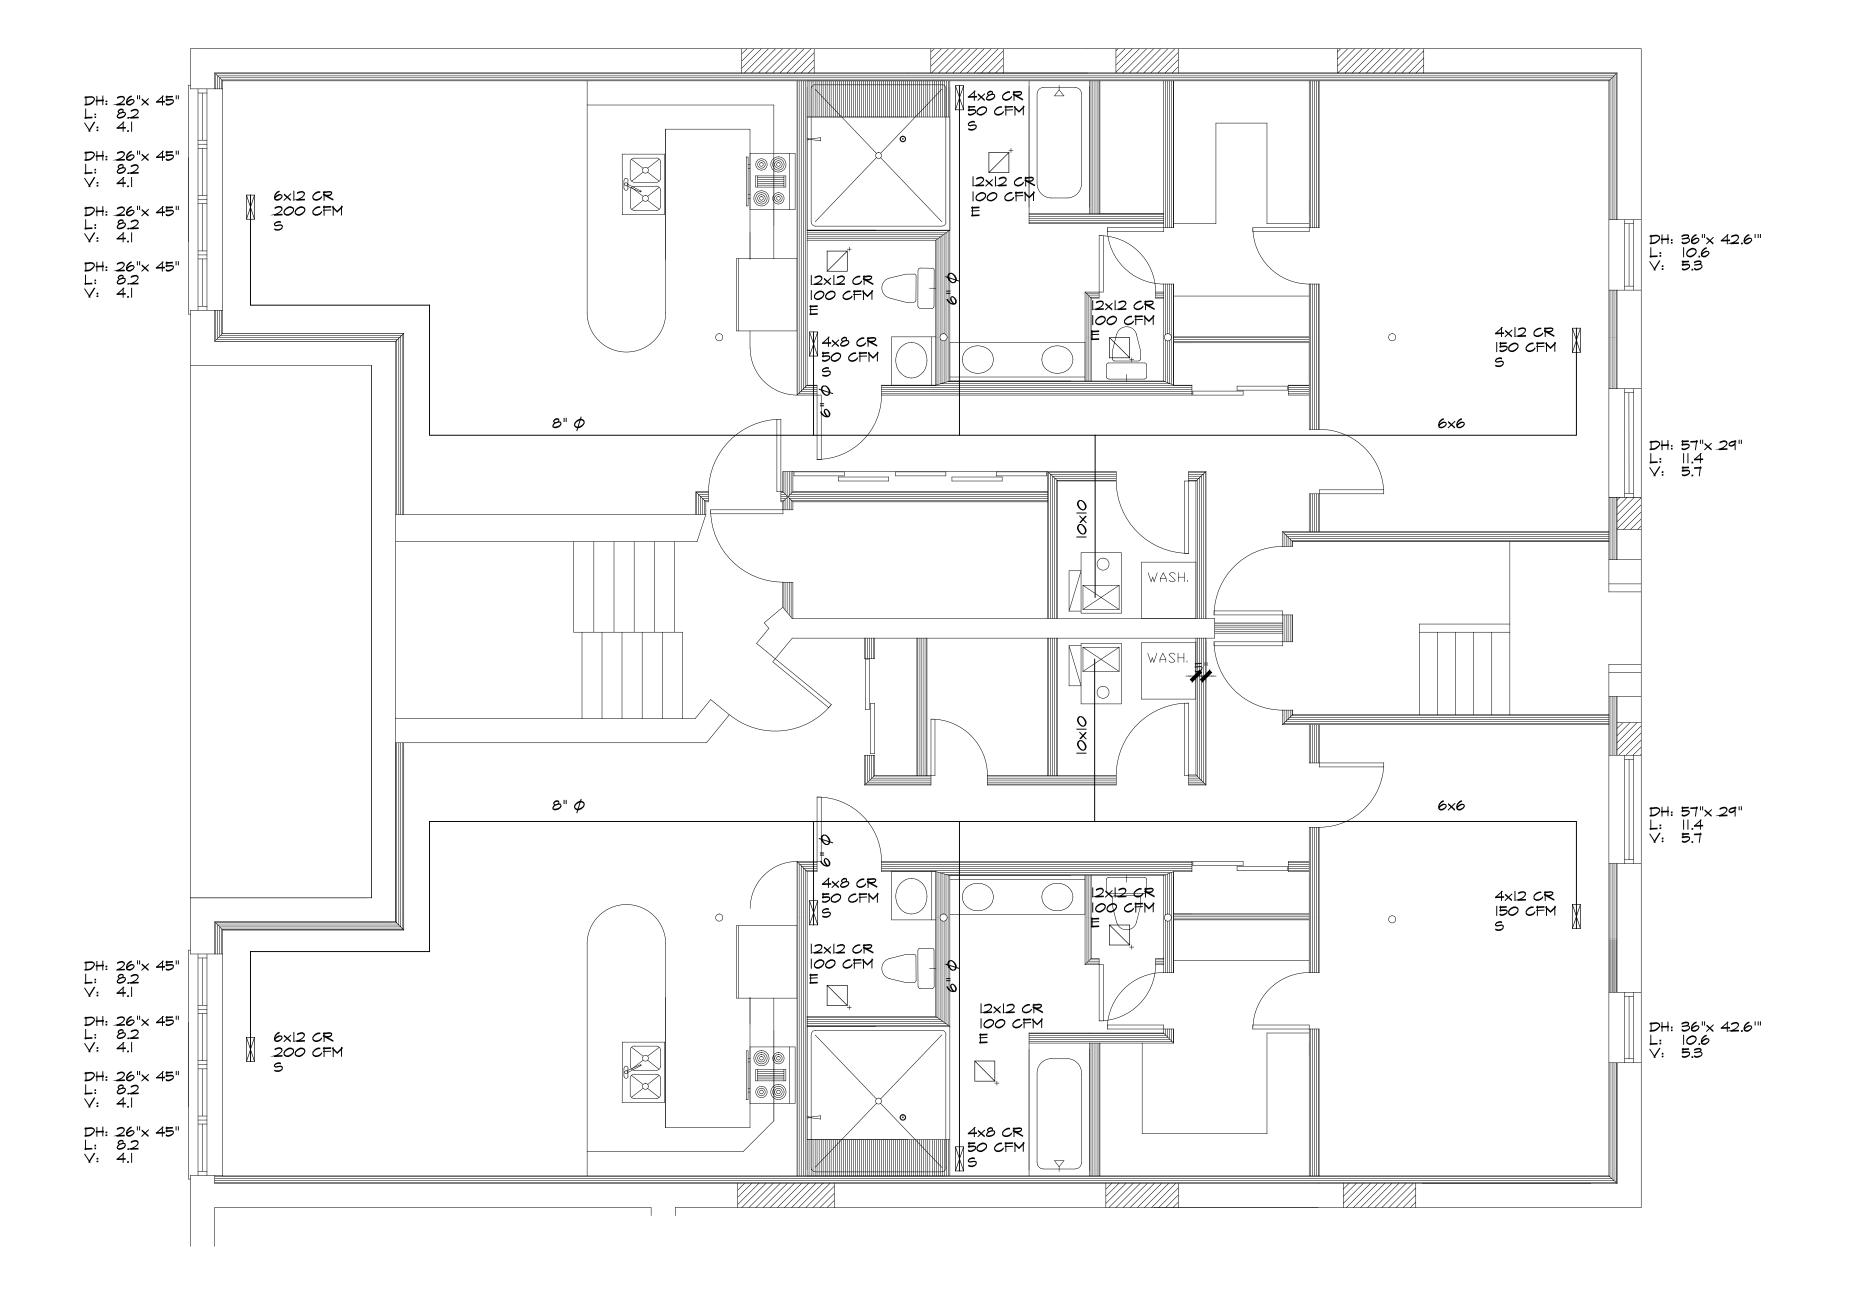

ELECTRICAL PLAN - BASEMENT SCALE: 1/4" = 1'-0"

MECHANICAL NOTES:

- I. THIS CONTRACTOR SHALL VISIT THE SITE AND BE FAMILIAR WITH THE JOB CONDITION PRIOR TO SUBMITTING THE BID.
- 2. THIS CONTRACTOR SHALL PAY FOR ALL THE TAXES AND FEES AND GIVE LOCAL AUTHORITIES ALL NOTICES RELATING TO.
- 3. WORKMANSHIP SHALL BE DONE IN A FIRST CLASS MANNER.
- 4. ALL MATERIALS USED FOR THIS JOB SHALL BE NEW AND THE BEST OF THEIR KIND.
- 5. ALL WORK SHALL BE DONE IN ACCORDANCE WITH ALL STATE AND LOCAL CODES
- 6. THIS CONTRACTOR SHALL GUARANTEE ALL WORK AND MATERIAL FOR ONE YEAR AFTER COMPLETION AGAINST ALL DEFECTS
- 7. THIS CONTRACTOR TO TEST SYSTEM PRIOR TO OPERATION.
- 8. HEAT ALL ROOMS -10 DEGREES OUTSIDE TO TO DEGREES INSIDE.
- 9. ALL SUPPLY BRANCHES ARE TO BE DAMPERED AND BALANCED. ALL DAMPERS SHALL BE LOCK-TYPE
- 10. ALL SUPPLY AND RETURN AIR DUCTS ARE TO BE INSULATED WITH 1/2" DUCT LINER OR EQUAL AIRWAY SIZES SHOWN ON THE PLAN. (OWNER'S OPTION, SUBMIT BID WITH AND WITHOUT)
- II. REGISTER'S, GRILLES, AND DIFFUSERS ARE TO BE HART AND COOLEY OR EQUAL. FLOOR REGISTERS SHALL BE MAXIMUM 9" AWAY FROM WALL.
- 12. ALL DUCTWORK IS TO FABRICATED IN SHEET METAL AND INSTALLED PER LATEST A.S.H.R.A.E. RECOMMENDATIONS.
- I3. ALL FRESH AIR INTAKES SHALL HAVE MANUAL DAMPERS PER UNIT, BACK DRAFT DAMPERS AND INSECT SCREEN.
- 14. ALL EXHAUST FANS ARE TO BE INSTALLED WITH ROOF CURBS, BACK DRAFT DAMPERS AND BIRD SCREENS.
- 15. ALL CUTTING AND PATCHING CAUSED BY THIS WORK SHALL BE DONE BY THIS CONTRACTOR.
- 16. ALL OPENINGS THRU THE ROOF SHALL BE PROVIDED BY THIS CONTRACTOR.
- 17. THE EQUIPMENT NOISE LEVEL SHALL NOT EXCEED 55 DBA AT THE LOT LINE.
- 18. ALL O.A.I. SHALL BE MIN. 15'-O" AWAY FROM ANY EXHAUST OR CONTAMINANTS AND 10' ABOVE GRADE.
- 19. ALL FURNACES SHALL HAVE A HUMIDIFYING DEVICE.
- 20. ALL WORK IS TO CONFORM WITH THE CITY OF CHICAGO BUILDING CODES.

VENTILATION SCHEDULE / HEATING SCHEDULE

| | | NATI | JRAL V | ENTILA- | TION | MECHA | ANICAL | VENTIL | ATION | HE/ | ATING DA | TA | HEATING DATA | | | |
|--------------|---------------|-----------------|----------------|-----------------|----------------|-------|--------------|----------------|-------|-------------|----------------|-----------------------|--------------|---------|--|--|
| ROOM PURPOSE | FLOOR AREA | CODE | | ACTUAL | | CODE | CODE REQ. | | UAL | BASIS OF | ACTUAL LOSS | SUPPLY CFM @ 75° F | | REMARKS | | |
| | (SQ. FT.) | GLASS (S.F.) | VENT (S.F.) | GLASS (S.F.) | VENT (S.F.) | SUP. | EXH (CFM) | GLASS (CFM) | | | (BTU/H) | ORD. REQ. | ACTUAL | | | |
| WEST UNIT | • | | | • | | • | | | | | SF*45 | | | | | |
| LIVNG/KITCH | 359 | 28 | 14 | 32.8 | 16.4 | | | | | NMAH # ACA | 16155 | 143 | 200 | | | |
| BED ROOM I | 224 | 18 | ٩. | 22.0 | 11.0 | | | | | NMAH # ACA | 10080 | 89 | 150 | | | |
| BATH I | 32 | NR | NR | NR | NR | | | | | NMAH # ACA | 1440 | 50 | 50 | | | |
| BATH 2 | 129 | NR | NR | NR | NR | | | | | NMAH # ACA | 5805 | 50 | 50 | | | |
| | | | | | | | | | | | | | | | | |
| | | | | | | | | | | TOTAL LOSS | 33480 | TOTAL | 450 | | | |
| | | | | | | | | | | TOTAL X 15% | 38502 | IOIAL | 1 -50 | | | |

FURNACE SCHEDULE

| TAG | MANUFACTURER | MODEL # | INPUT (BTUH) | OUTPUT (BTUH) | OFM | ORIENTATION | LOCATION |
|-----|--------------|---------|--------------|---------------|-----|-------------|-------------|
| F-I | LENNOX | LENNOX | 88,000 | 81,000 | - | UPFLOW | BASEMENT |
| F-2 | LENNOX | LENNOX | 70,000 | 60,000 | - | UPFLOW | CRAWL-SPACE |
| F-3 | LENNOX | LENNOX | 90,000 | 72,000 | - | DOWNFLOW | ATTIC |
| | | | | | | | |

EXHAUST FAN SCHEDULE

| TAG | MANUFACTURER | MODEL # | OUTPUT (CFM) |
|-------|--------------|---------|--------------|
| EXH-I | BROAN | BROAN | 100 |
| | | | |

1 1

> REHABILIT RESIDENTIA


EDWARD M. YUNG DATE ISSUED:

3-18-2016

PROJECT # 1603

SHEET TITLE: MECHANICAL PLAN -PLANS, SCHEDULES & NOTES

M-1

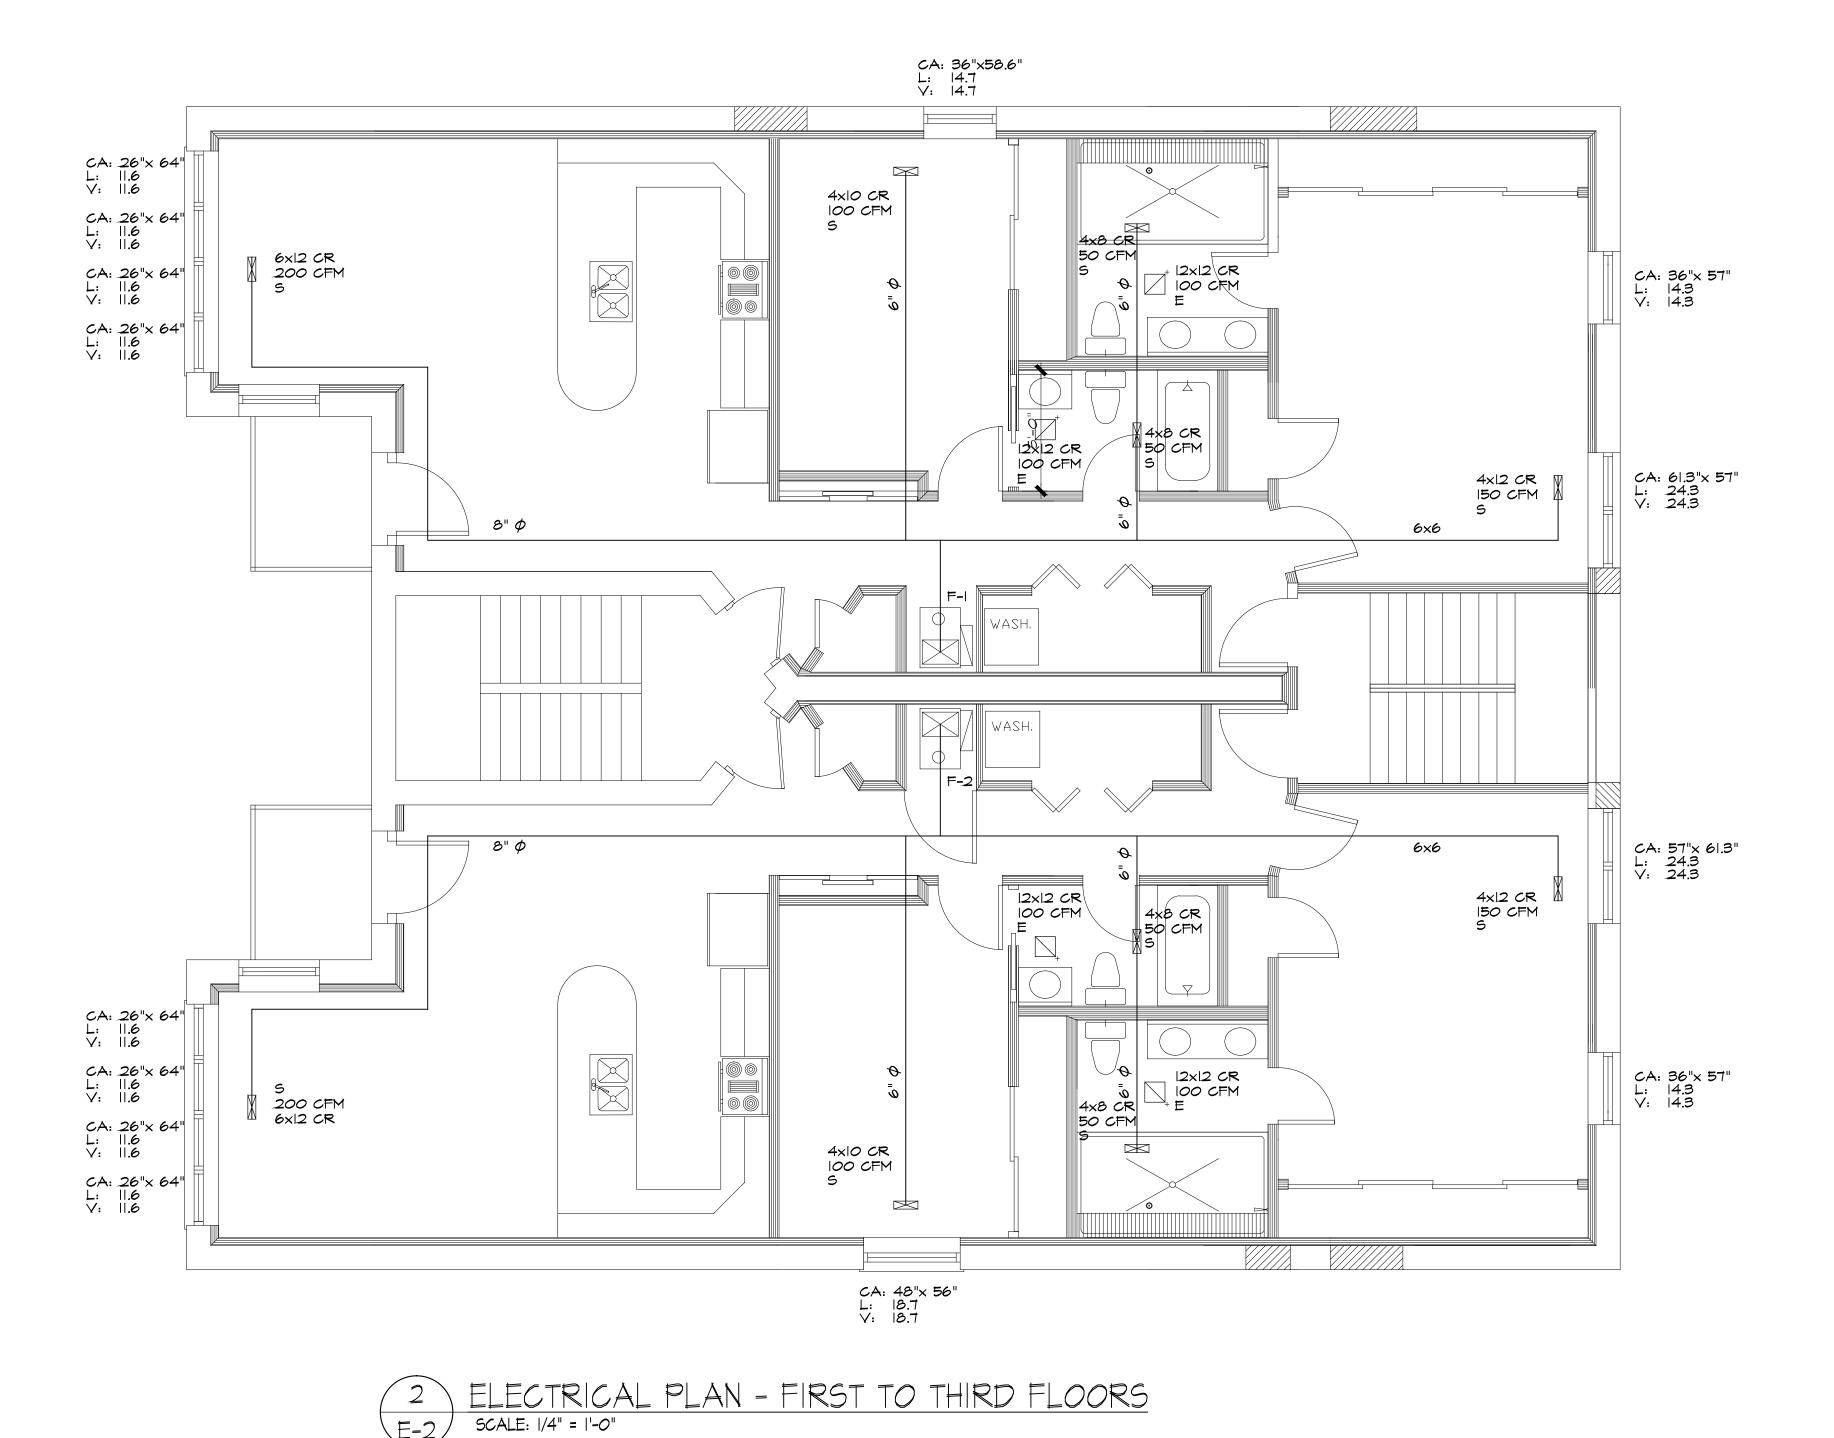

MECHANICAL NOTES:

- I. THIS CONTRACTOR SHALL VISIT THE SITE AND BE FAMILIAR WITH THE JOB CONDITION PRIOR TO SUBMITTING THE BID.
- 2. THIS CONTRACTOR SHALL PAY FOR ALL THE TAXES AND FEES AND GIVE LOCAL AUTHORITIES ALL NOTICES RELATING TO.
 HIS WORK.
- 3. WORKMANSHIP SHALL BE DONE IN A FIRST CLASS MANNER.
- 4. ALL MATERIALS USED FOR THIS JOB SHALL BE NEW AND THE BEST OF THEIR KIND.
- 5. ALL WORK SHALL BE DONE IN ACCORDANCE WITH ALL STATE AND LOCAL CODES
- 6. THIS CONTRACTOR SHALL GUARANTEE ALL WORK AND MATERIAL FOR ONE YEAR AFTER COMPLETION AGAINST ALL DEFECTS
- 7. THIS CONTRACTOR TO TEST SYSTEM PRIOR TO OPERATION.
- 8. HEAT ALL ROOMS -10 DEGREES OUTSIDE TO TO DEGREES INSIDE.
- 9. ALL SUPPLY BRANCHES ARE TO BE DAMPERED AND BALANCED. ALL DAMPERS SHALL BE LOCK-TYPE
- IO. ALL SUPPLY AND RETURN AIR DUCTS ARE TO BE INSULATED WITH 1/2" DUCT LINER OR EQUAL AIRWAY SIZES SHOWN ON THE PLAN.
 (OWNER'S OPTION, SUBMIT BID WITH AND WITHOUT)
- II. REGISTER'S, GRILLES, AND DIFFUSERS ARE TO BE HART AND COOLEY OR EQUAL. FLOOR REGISTERS SHALL BE MAXIMUM 9" AWAY FROM WALL.
- 12. ALL DUCTWORK IS TO FABRICATED IN SHEET METAL AND INSTALLED PER LATEST A.S.H.R.A.E. RECOMMENDATIONS.
- 13. ALL FRESH AIR INTAKES SHALL HAVE MANUAL DAMPERS PER UNIT, BACK DRAFT DAMPERS AND INSECT SCREEN.
- 14. ALL EXHAUST FANS ARE TO BE INSTALLED WITH ROOF CURBS, BACK DRAFT DAMPERS AND BIRD SCREENS.
- 15. ALL CUTTING AND PATCHING CAUSED BY THIS WORK SHALL BE DONE BY THIS CONTRACTOR.
- 16. ALL OPENINGS THRU THE ROOF SHALL BE PROVIDED BY THIS CONTRACTOR.
- 17. THE EQUIPMENT NOISE LEVEL SHALL NOT EXCEED 55 DBA AT THE LOT LINE.
- 18. ALL O.A.I. SHALL BE MIN. 15'-O" AWAY FROM ANY EXHAUST OR CONTAMINANTS AND 10' ABOVE GRADE.
- 19. ALL FURNACES SHALL HAVE A HUMIDIFYING DEVICE.
- 20. ALL WORK IS TO CONFORM WITH THE CITY OF CHICAGO BUILDING CODES.

VENTILATION SCHEDULE / HEATING SCHEDULE

| | | NATURAL VENTILATION | | | MECHA | MECHANICAL VENTILATION | | | HEATING DATA | | | | | |
|--------------|----------------------------|---------------------|----------------|--------------------|-------|------------------------|----------|-----------------------|--------------|---------------------------|-----------------|-------|--------|--|
| ROOM PURPOSE | FLOOR AREA (SQ. FT.) | CODE REQ. ACTUAL | | CODE REQ. ACTUAL | | BASIS OF | ACTUAL | SUPPLY CFM @ 75° F | | REMARKS | | | | |
| NOOM FOR OSE | | GLASS (S.F.) | VENT (S.F.) | GLASS (S.F.) | ı | SUP. (CFM) | | GLASS (CFM) | | HEAT LOSS CALCULATIONS | LOSS (BTU/H) | ORD. | ACTUAL | |
| FIRST FLOOR | | | | | | • | • | | | | SF*45 | | • | |
| LIVNG/KITCH | 340 | .27 | 13.5 | 46.4 | 46.4 | | | | | NMAH # ACA | 15300 | 135 | 200 | |
| BED ROOM I | 138 | П | 5.5 | 14.7 | 14.7 | | | | | NMAH # ACA | 6210 | 55 | 100 | |
| BED ROOM 2 | 234 | 19 | 9.5 | 38.6 | 38.6 | | | | | NMAH # ACA | 10530 | 93 | 150 | |
| BATH I | 38 | NR | NR | | | | | | | NMAH # ACA | 1710 | 50 | 50 | |
| BATH 2 | 58 | NR | NR | | | | | | | NMAH # ACA | 2610 | 50 | 50 | |
| | | | | | | | | | | | | | | |
| | I | | | | | <u> </u> | <u> </u> | | | TOTAL LOSS | 36360 | TOTAL | 550 | |
| | | | | | | | | | | TOTAL X 15% | 4 8 4 | | | |

FURNACE SCHEDULE

| TAG | MANUFACTURER | MODEL # | INPUT (BTUH) | OUTPUT (BTUH) | CFM | ORIENTATION | LOCATION |
|-----|--------------|------------------|--------------|---------------|-----|-------------|-----------|
| F-I | LENNOX | ML193UHI10P60C M | 60,000 | 55,000 | - | UPFLOW | EACH UNIT |
| F-2 | LENNOX | ML193UH110P60C M | 60,000 | 55,000 | 1 | UPFLOW | EACH UNIT |
| | | | | | | | |


EXHAUST FAN SCHEDULE

| TAG | MANUFACTURER | MODEL # | OUTPUT (CFM) |
|-------|--------------|---------|--------------|
| EXH-I | BROAN | BROAN | 100 |

YUNG Architects PLANNERS / INTERIORS / CONSTRUCTION MANAGERS

RESIDENTIAL REHABILITATION 350 EAST 50TH STREET

NUMBER REVISIONS DATE

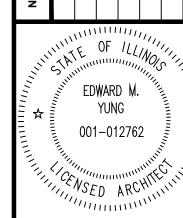


DATE ISSUED: 3-18-2016

PROJECT # 1603

SHEET TITLE:

MECHANICAL PLAN PLANS, SCHEDULES
& NOTES

M-1

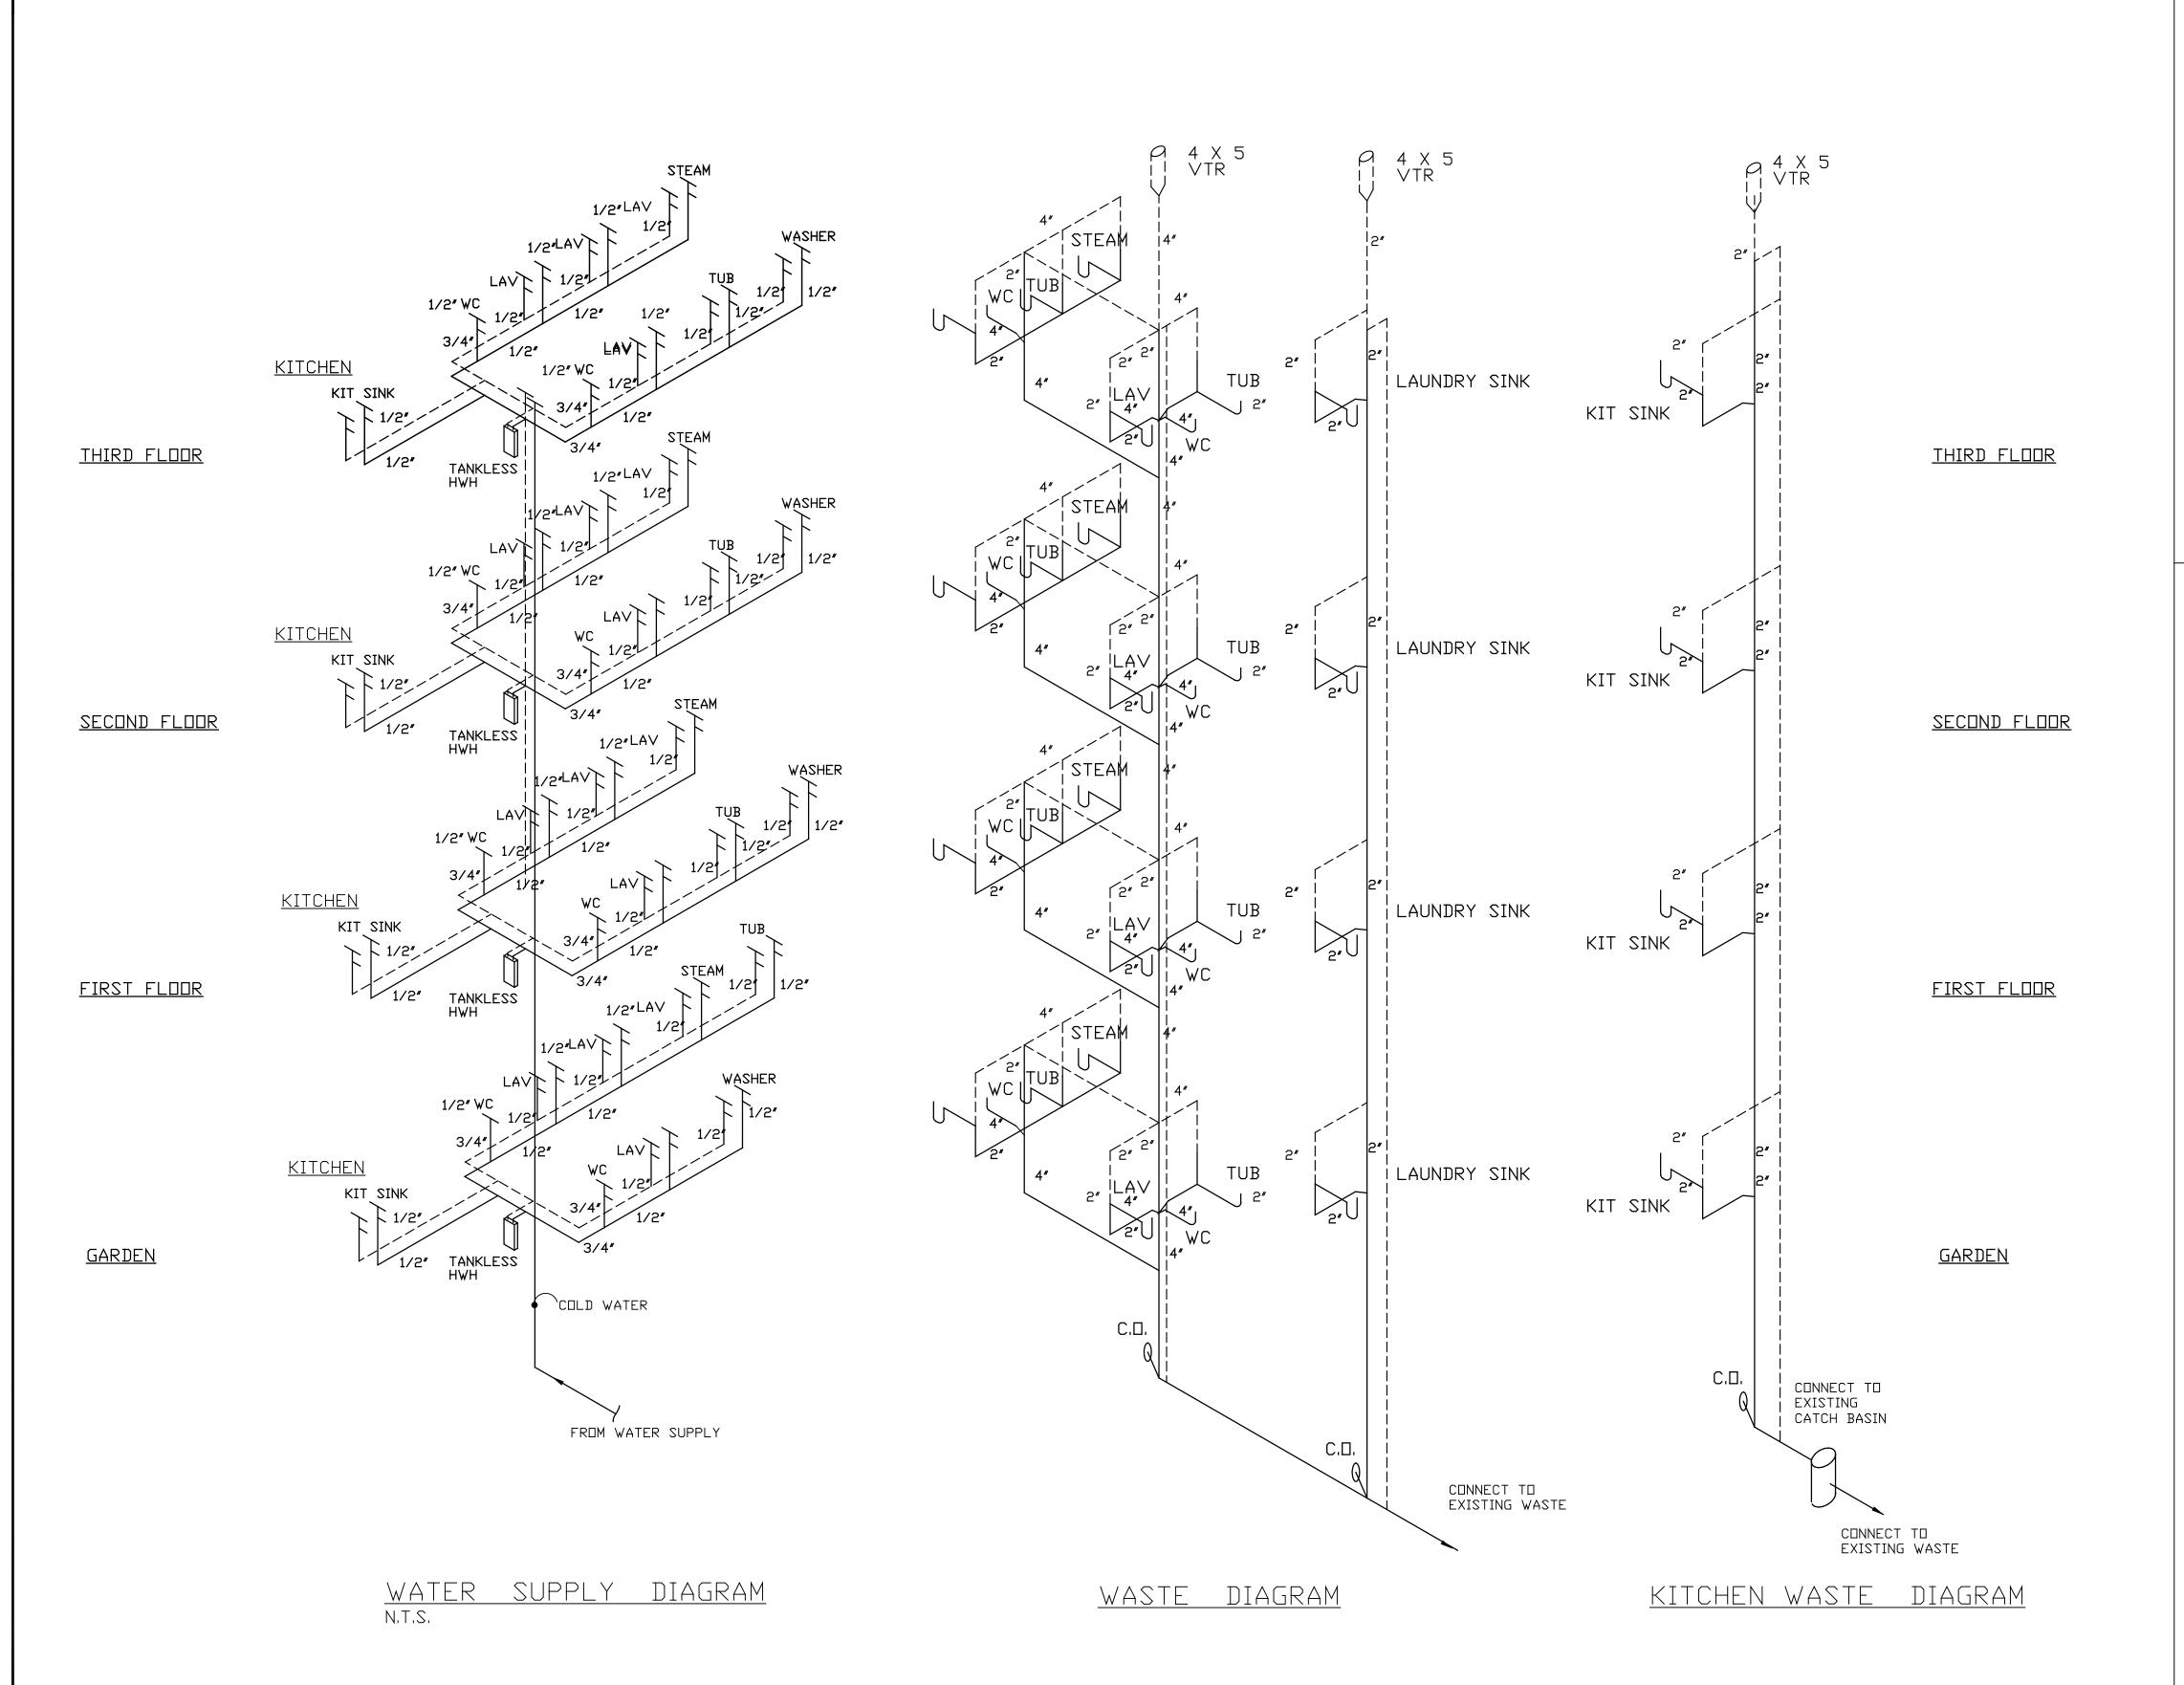

PLUMBING NOTES:

- I. THIS CONTRACTOR SHALL VISIT THE SITE AND BE FAMILIAR WITH THEJOB CONDITION PRIOR TO SUBMITTING THE BID.
- 2. THIS CONTRACTOR SHALL PAY FOR ALL THE TAXES AND FEES AND GIVE LOCAL AUTHORITIES ALL NOTICES RELATING TO HIS WORK.
- 3. WORKMANSHIP SHALL BE DONE IN A FIRST CLASS MANNER.
- 4. ALL MATERIALS USED FOR THIS JOB SHALL BE NEW AND THE BEST OF THEIR KIND.
- 5. ALL WORK SHALL BE DONE IN ACCORDANCE WITH ALL STATE AND LOCAL CODES.
- 6. THIS CONTRACTOR SHALL GUARANTEE ALL WORK AND MATERIAL FOR ONE YEAR AFTER COMPLETION AGAINST ALL DEFECTS OF MATERIAL, EQUIPMENTS AND WORKMANSHIP.
- 7. THIS CONTRACTOR TO TEST SYSTEM PRIOR TO OPERATION.
- 8. ALL CUTTING AND PATCHING CAUSED BY THIS WORK SHALL BE DONE BY THIS CONTRACTOR.
- 9. ALL OPENINGS THRU THE ROOF SHALL BE PROVIDED BY THIS CONTRACTOR.
- IO. ALL ABOVE GROUND VENTS AND SEMER PIPING SHALL BE STANDARD MEIGHT CAST IRON.
- II. ALL NEW DOMESTIC HOT AND COLD WATER LINES SHALL BE SCHEDULE 40 GALVANIZED
 STEEL PIPE WITH GALVANIZED MALLEABLE IRON SCREWED FITTINGS OR COPPER TYPE
 "L" PIPING.
- 12. INSULATE ALL CONCEALED COLD WATER PIPING WITH "L" FIBERGLASS INSULATION WITH VAPOR BARRIER. INSULATE ALL COLD WATER PIPING IN BASEMENT.
- 13. VENT STACK SHALL TERMINATE AT A POINT 12" ABOVE THE ROOF.
- 14. REMOVE ALL UNUSED PIPING TO WITHIN THE WALLS OR FLOORS AND CAP.
- 15. INSTALL NEW PIPING AS SHOWN ON DRAWINGS. ALL PIPING TO BE CONCEALED IN WALLS AND FLOORS.
- 16. INSTALL NEW SHUT-OFF VALVES AT EACH FIXTURE.
- 17. CONTRACTOR TO VERIFY USE OF EXISTING SUMP PIT. IF EXISTING PUMP USE FOR SANITARY, CONNECT WASTE LINE TO PIT. IF PIT USE FOR WATER DRAINAGE. NEW SUMP PIT WITH EJECTOR OR PUMP & CHECK VALVE REQUIRED.
- 18. ALL WORK IS TO CONFORM WITH THE CITY OF CHICAGO BUILDING CODES & ILLINOIS STATE PLUMBING CODES

FIXTURE COUNT - IST FLOOR

| | EXISTING | NEM | REPLACED |
|------------------|----------|-----|----------|
| WATER CLOSET | 1 | - | I |
| LAVATORIES | 1 | - | I |
| TUBS | 1 | - | I |
| SHOWERS | - | - | - |
| MASHERS | - | I | - |
| KITCHEN SINKS | 1 | - | I |
| DISHWASHER | - | I | - |
| FLOOR DRAINS | - | I | _ |
| HOT WATER HEATER | I | - | I |
| TOTAL | 5 | 3 | 5 |
| TOTAL FOR FLOOR | | 8 | |
| | | | |

FIXTURE COUNT - 2ND FLOOR

| | EXISTING | NEX | REPLACED |
|------------------|----------|-----|----------|
| WATER CLOSET | 1 | 2 | I |
| LAVATORIES | 1 | 4 | I |
| TUBS | 1 | - | I |
| SHOWERS | - | 2 | - |
| MASHERS | - | I | - |
| KITCHEN SINKS | 1 | - | - |
| DISHWASHER | - | - | - |
| FLOOR DRAINS | - | I | - |
| HOT WATER HEATER | - | I | - |
| TOTAL | э | Ш | 3 |
| TOTAL FOR FLOOR | | 14 | |
| | | | |

TUNG Architects HITECTS/PLANNERS/INTERIORS/CONSTRUCTION MANAGERS

RESIDENTIAL REHABILITATION 350 EAST 50TH STREET

EDWARD M.

YUNG

OO1-012762

WARD M.

YUNG


OO1-012762

DATE ISSUED: 3-18-2016

PROJECT # 1603

SHEET TITLE:
PLUMBING PLANS,
SCHEDULE, RISER
DIAGRAMS & NOTES

T#: **P-**'

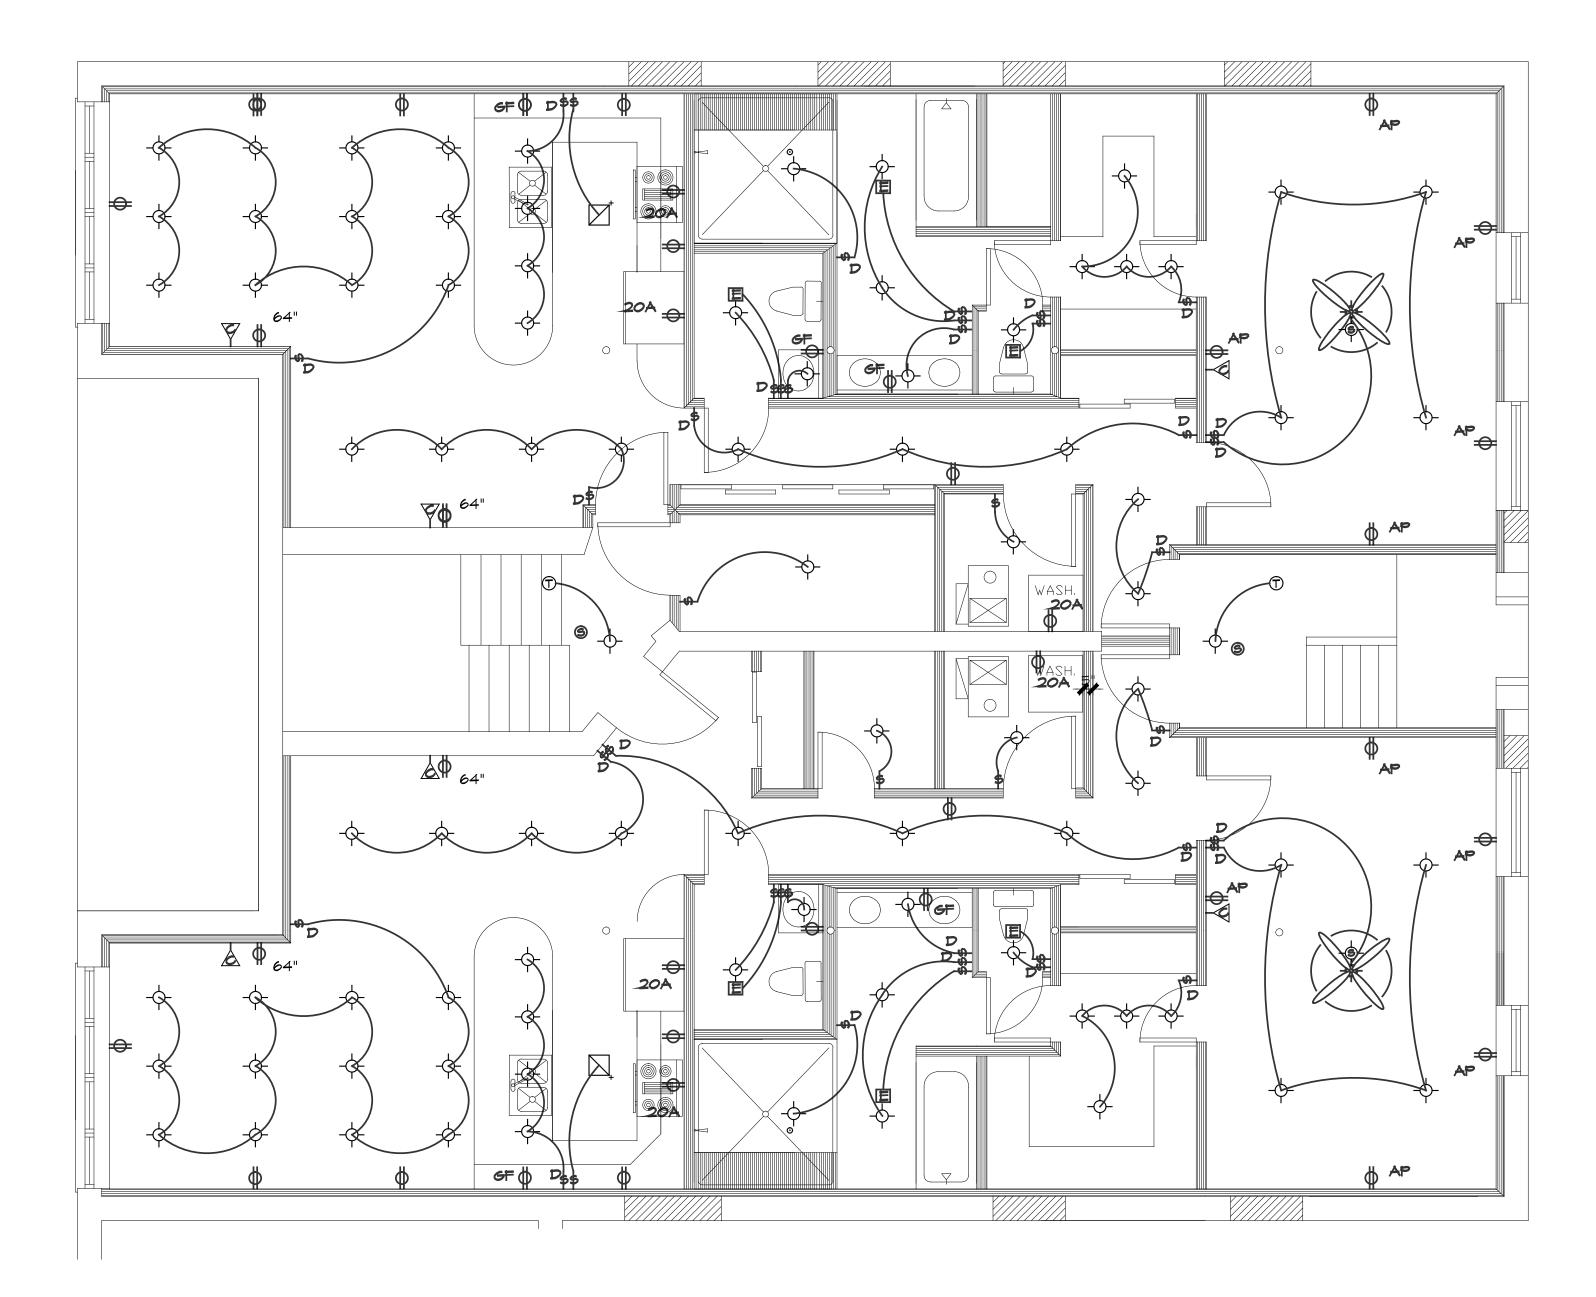

ELECTRICAL PLAN - BASEMENT

ELECTRICAL LEGEND

RECESSED LED LIGHT FIXTURE

SURFACE MTD. LED LIGHT FIXTURE

FLOURESCENT LIGHT FIXTURE

SMOKE DETECTOR HARD WIRED - 110 V. BATTERY BACKUP

CARBON MONOXIDE DETECTOR

DUPLEX OUTLET

DUPLEX OUTLET W/ GROUND FAULT INTERRUPTER

DUPLEX OUTLET W/ 20 AMP

DUPLEX OUTLET W/ ARC PROTECTION

LIGHT SWITCH

3-MAY LIGHT SMITCH

DIMMER LIGHT SWITCH

EXHAUST FAN

ELECTRICAL PANEL

CEILING FAN

ELECTRICAL NOTES:

- I. THIS CONTRACTOR SHALL VISIT THE SITE AND BE FAMILIAR WITH THE JOB CONDITION PRIOR TO SUBMITTING THE BID.
- 2. THIS CONTRACTOR SHALL PAY FOR ALL THE TAXES AND FEES AND GIVE LOCAL AUTHORITIES ALL NOTICES RELATING TO HIS WORK.
- 3. WORKMANSHIP SHALL BE DONE IN A FIRST CLASS MANNER.
- 4. ALL MATERIALS USED FOR THIS JOB SHALL BE NEW AND THE BEST OF THEIR KIND.
- 5. ALL WORK SHALL BE DONE IN ACCORDANCE WITH ALL STATE AND LOCAL CODES.
- 6. THIS CONTRACTOR SHALL GUARANTEE ALL WORK AND MATERIAL FOR ONE YEAR AFTER COMPLETION AGAINST ALL DEFECTS OF MATERIAL, EQUIPMENT AND WORKMANSHIP.
- 7. THIS CONTRACTOR TO TEST SYSTEM PRIOR TO OPERATION.
- 8. UNLESS OTHERWISE NOTED, DISCONNECT AND REMOVE EXISTING ITEMS SUCH AS LIGHTING FIXTURES, OUTLETS, ETC. THAT ARE RENDERED OBSOLETE DUE TO THE ALTERATIONS AND/OR ADDITION. REMOVE ASSOCIATED WIRING AND EXPOSED CONDUIT, CAP AND ABANDON CONCEALED CONDUIT.
- 9. ELECTRICAL CONTRACTOR SHALL REMOVE ALL EXISTING RECEPTACLES, CONDUIT, LIGHTING FIXTURES AND DEVICES IN AREAS WHERE CEILING, WALLS, FLOORS OR PARTITIONS ARE RE-WORKED OR REMOVED. THE CONTRACTOR SHALL TAKE ADEQUATE CARE AND CAUTION AS NOT TO DAMAGE ADJACENT SURFACES.
- IO INSTALL NEW SWITCHES AND GROUNDING-TYPE RECEPTACLES. INSTALL NEW CONDUIT AND WIRING TO ALL NEW FIXTURES, SWITCHES AND RECEPTACLES.
- II. INSTALL NEW LIGHT FIXTURES AND CEILING FANS. LIGHT FIXTURES AND CEILING FANS TO BE SUPPLIED BY THE OWNER.
- 12. SWITCHES, RECEPTACLES, TELEPHONE OUTLETS, ETC. SHALL NOT BE INSTALLED BACK TO BACK. ALL RECEPTACLES AND TELEPHONE OUTLETS TO BE INSTALLED 1'-0" A.F.F. UNLESS NOTED, SWITCHES 54" A.F.F.
- 13. CONDUIT RUNS SHOWN ON THE DRAWINGS ARE DIAGRAMMATIC. ACTUAL FIELD CONDITIONS SHOULD BE FOLLOWED.
- 14. WHERE AS A RESULT OF CHANNELING THROUGH OF A CONDUIT, EXISTING PLASTER WALLS ARE MARRED, THE ELECTRICAL CONTRACTOR SHALL BE RESPONSIBLE FOR THEIR REPAIR. HE SHALL PATCH SUCH AREAS TO A DEGREE OF FINISH AS TO BE PAINTABLE BY ACCEPTABLE STANDARDS OF THE DAY.
- 15. ALL SYSTEMS SHALL BE COMPLETE AND OPERATING, PROVIDE ALL MATERIALS, CONDUIT WIRING, JUNCTION BOXES, ETC. AS REQUIRED.
- 16. ALL FIXTURES SHALL BE INSTALLED AT THE HEIGHT NOTED IN THE LIGHTING SCHEDULE.
- 17. APPROVED TYPE CEILING BOXES ARE REQUIRED FOR PADDLE FAN NOT IN EXCESS OF 35
- 18. CLOSET LIGHTS SHALL OF THE FOLLOWING CLEARANCE FROM SHELVES AND HAVE A GLOBE OVER IT:
 - 18.1. FLUORESCENT FIXTURES SHALL HAVE A 6" SPACE FROM THE EDGE OF THE SHELF.
 - 18.2. INCANDESCENT FIXTURES SHALL HAVE A 12" SPACE FROM THE EDGE OF THE SHELF.
- 19. ALL OUTLETS TO BE MOUNTED ABOVE COUNTERTOP IN KITCHEN.
- 20. ALL ELECTRICAL OUTLETS WITHIN 6'-O" OF ANY SINK OR WATER SOURCE SHALL BE GROUND FAULT PROTECTED.
- 21. ALL ELECTRICAL OUTLETS IN SLEEPING ROOMS & BEDROOMS SHALL BE "ARC-FAULT" PROTECTED.
- 22. ALL ELECTRICAL WORK SHALL COMPLY WITH THE CITY OF CHICAGO BUILDING CODES.

1

ATION EHABILIT,

RESIDENTIA


TATE OF ILLING. EDWARD M. YUNG 001-012762 CENSED ARCH

DATE ISSUED: 3-18-2016

PROJECT # 1603

SHEET TITLE: ELECTRICAL PLAN -PLANS, SCHEDULES, & NOTES

SHEET #:

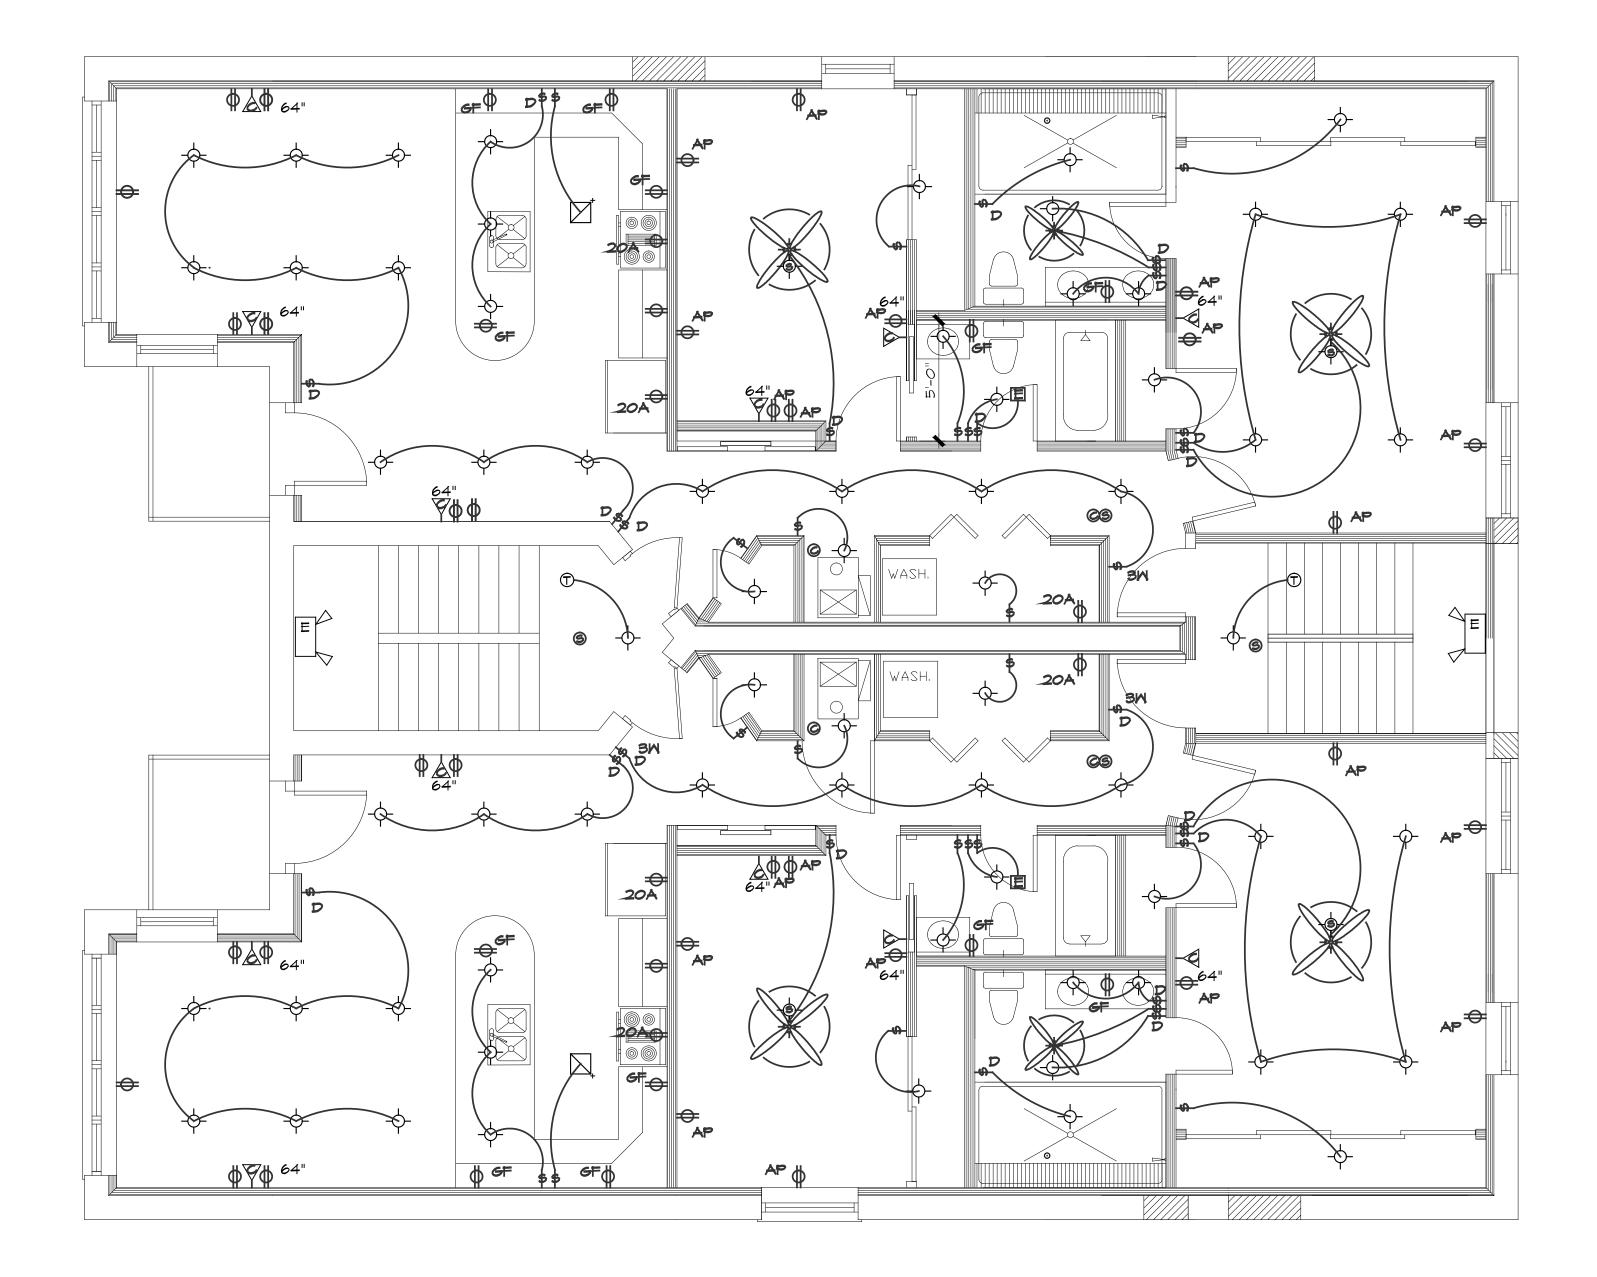

2 ELECTRICAL PLAN = FIRST TO THIRD FLOORS

SCALE: 1/4" = 1'-0"

ELECTRICAL LEGEND

)- RECESSED LED LIGHT FIXTURE

SURFACE MTD. LED LIGHT FIXTURE

FLOURESCENT LIGHT FIXTURE

SMOKE DETECTOR HARD WIRED - 110 V. BATTERY BACKUP

CARBON MONOXIDE DETECTOR

DUPLEX OUTLET

DUPLEX OUTLET W/ GROUND FAULT INTERRUPTER

#20A DUPLEX OUTLET W/ 20 AMP

AP DUPLEX OUTLET W/ ARC PROTECTION

LIGHT SMITCH

\$3W 3-MAY LIGHT SMITCH

DIMMER LIGHT SMITCH

E EXHAUST FAN

ELECTRICAL PANEL

CEILING FAN

ELECTRICAL NOTES:

- I. THIS CONTRACTOR SHALL VISIT THE SITE AND BE FAMILIAR WITH THE JOB CONDITION PRIOR TO SUBMITTING THE BID.
- THIS CONTRACTOR SHALL PAY FOR ALL THE TAXES AND FEES AND GIVE LOCAL AUTHORITIES ALL NOTICES RELATING TO HIS WORK.
- 3. WORKMANSHIP SHALL BE DONE IN A FIRST CLASS MANNER.
- 4. ALL MATERIALS USED FOR THIS JOB SHALL BE NEW AND THE BEST OF THEIR KIND.
- 5. ALL WORK SHALL BE DONE IN ACCORDANCE WITH ALL STATE AND LOCAL CODES.
- 6. THIS CONTRACTOR SHALL GUARANTEE ALL WORK AND MATERIAL FOR ONE YEAR AFTER COMPLETION AGAINST ALL DEFECTS OF MATERIAL, EQUIPMENT AND WORKMANSHIP.
- 7. THIS CONTRACTOR TO TEST SYSTEM PRIOR TO OPERATION.
- 8. UNLESS OTHERWISE NOTED, DISCONNECT AND REMOVE EXISTING ITEMS SUCH AS LIGHTING FIXTURES, OUTLETS, ETC. THAT ARE RENDERED OBSOLETE DUE TO THE ALTERATIONS AND/OR ADDITION. REMOVE ASSOCIATED WIRING AND EXPOSED CONDUIT, CAP AND ABANDON CONCEALED CONDUIT.
- 9. ELECTRICAL CONTRACTOR SHALL REMOVE ALL EXISTING RECEPTACLES, CONDUIT, LIGHTING FIXTURES AND DEVICES IN AREAS WHERE CEILING, WALLS, FLOORS OR PARTITIONS ARE RE-WORKED OR REMOVED. THE CONTRACTOR SHALL TAKE ADEQUATE CARE AND CAUTION AS NOT TO DAMAGE ADJACENT SURFACES.
- IO INSTALL NEW SWITCHES AND GROUNDING-TYPE RECEPTACLES. INSTALL NEW CONDUIT AND WIRING TO ALL NEW FIXTURES, SMITCHES AND RECEPTACLES.
- II. INSTALL NEW LIGHT FIXTURES AND CEILING FANS. LIGHT FIXTURES AND CEILING FANS TO BE SUPPLIED BY THE OWNER.
- 12. SWITCHES, RECEPTACLES, TELEPHONE OUTLETS, ETC. SHALL NOT BE INSTALLED BACK TO BACK. ALL RECEPTACLES AND TELEPHONE OUTLETS TO BE INSTALLED 1'-O" A.F.F. UNLESS NOTED, SWITCHES 54" A.F.F.
- 13. CONDUIT RUNS SHOWN ON THE DRAWINGS ARE DIAGRAMMATIC. ACTUAL FIELD CONDITIONS SHOULD BE FOLLOWED.
- 14. WHERE AS A RESULT OF CHANNELING THROUGH OF A CONDUIT, EXISTING PLASTER WALLS ARE MARRED, THE ELECTRICAL CONTRACTOR SHALL BE RESPONSIBLE FOR THEIR REPAIR. HE SHALL PATCH SUCH AREAS TO A DEGREE OF FINISH AS TO BE PAINTABLE BY ACCEPTABLE STANDARDS OF THE DAY.
- 15. ALL SYSTEMS SHALL BE COMPLETE AND OPERATING, PROVIDE ALL MATERIALS, CONDUIT WIRING, JUNCTION BOXES, ETC. AS REQUIRED.
- 16. ALL FIXTURES SHALL BE INSTALLED AT THE HEIGHT NOTED IN THE LIGHTING SCHEDULE.
- 17. APPROVED TYPE CEILING BOXES ARE REQUIRED FOR PADDLE FAN NOT IN EXCESS OF 35 POUNDS.
- 18. CLOSET LIGHTS SHALL OF THE FOLLOWING CLEARANCE FROM SHELVES AND HAVE A GLOBE OVER IT:
 - 18.1. FLUORESCENT FIXTURES SHALL HAVE A 6" SPACE FROM THE EDGE OF
- 18.2. INCANDESCENT FIXTURES SHALL HAVE A 12" SPACE FROM THE EDGE OF THE SHELF.
- PROTECTED.

 19. ALL OUTLETS TO BE MOUNTED ABOVE COUNTERTOP IN KITCHEN.
- 20. ALL ELECTRICAL OUTLETS WITHIN 6'-0" OF ANY SINK OR WATER SOURCE SHALL BE GROUND FAULT PROTECTED.
- 21. ALL ELECTRICAL OUTLETS IN SLEEPING ROOMS & BEDROOMS SHALL BE "ARC-FAULT"
- 22. ALL ELECTRICAL WORK SHALL COMPLY WITH THE CITY OF CHICAGO BUILDING CODES.

UNGARCONSTRUCTION MANAGERS

ALIAL REPADILITATION
350 EAST 50TH STREET

RESIDENTIA 350 EA CHIC

DATE ISSUED: 3-18-2016

SHEET TITLE:


ELECTRICAL PLAN PLANS, SCHEDULES, & NOTES


PROJECT # 1603

SHEET #:



L REHABILITATION 350 EA RESIDENTIA EDWARD M. YUNG DATE ISSUED: 3-18-2016 PROJECT # 1603 SHEET TITLE: MASONRY PLAN -PLANS & NOTES

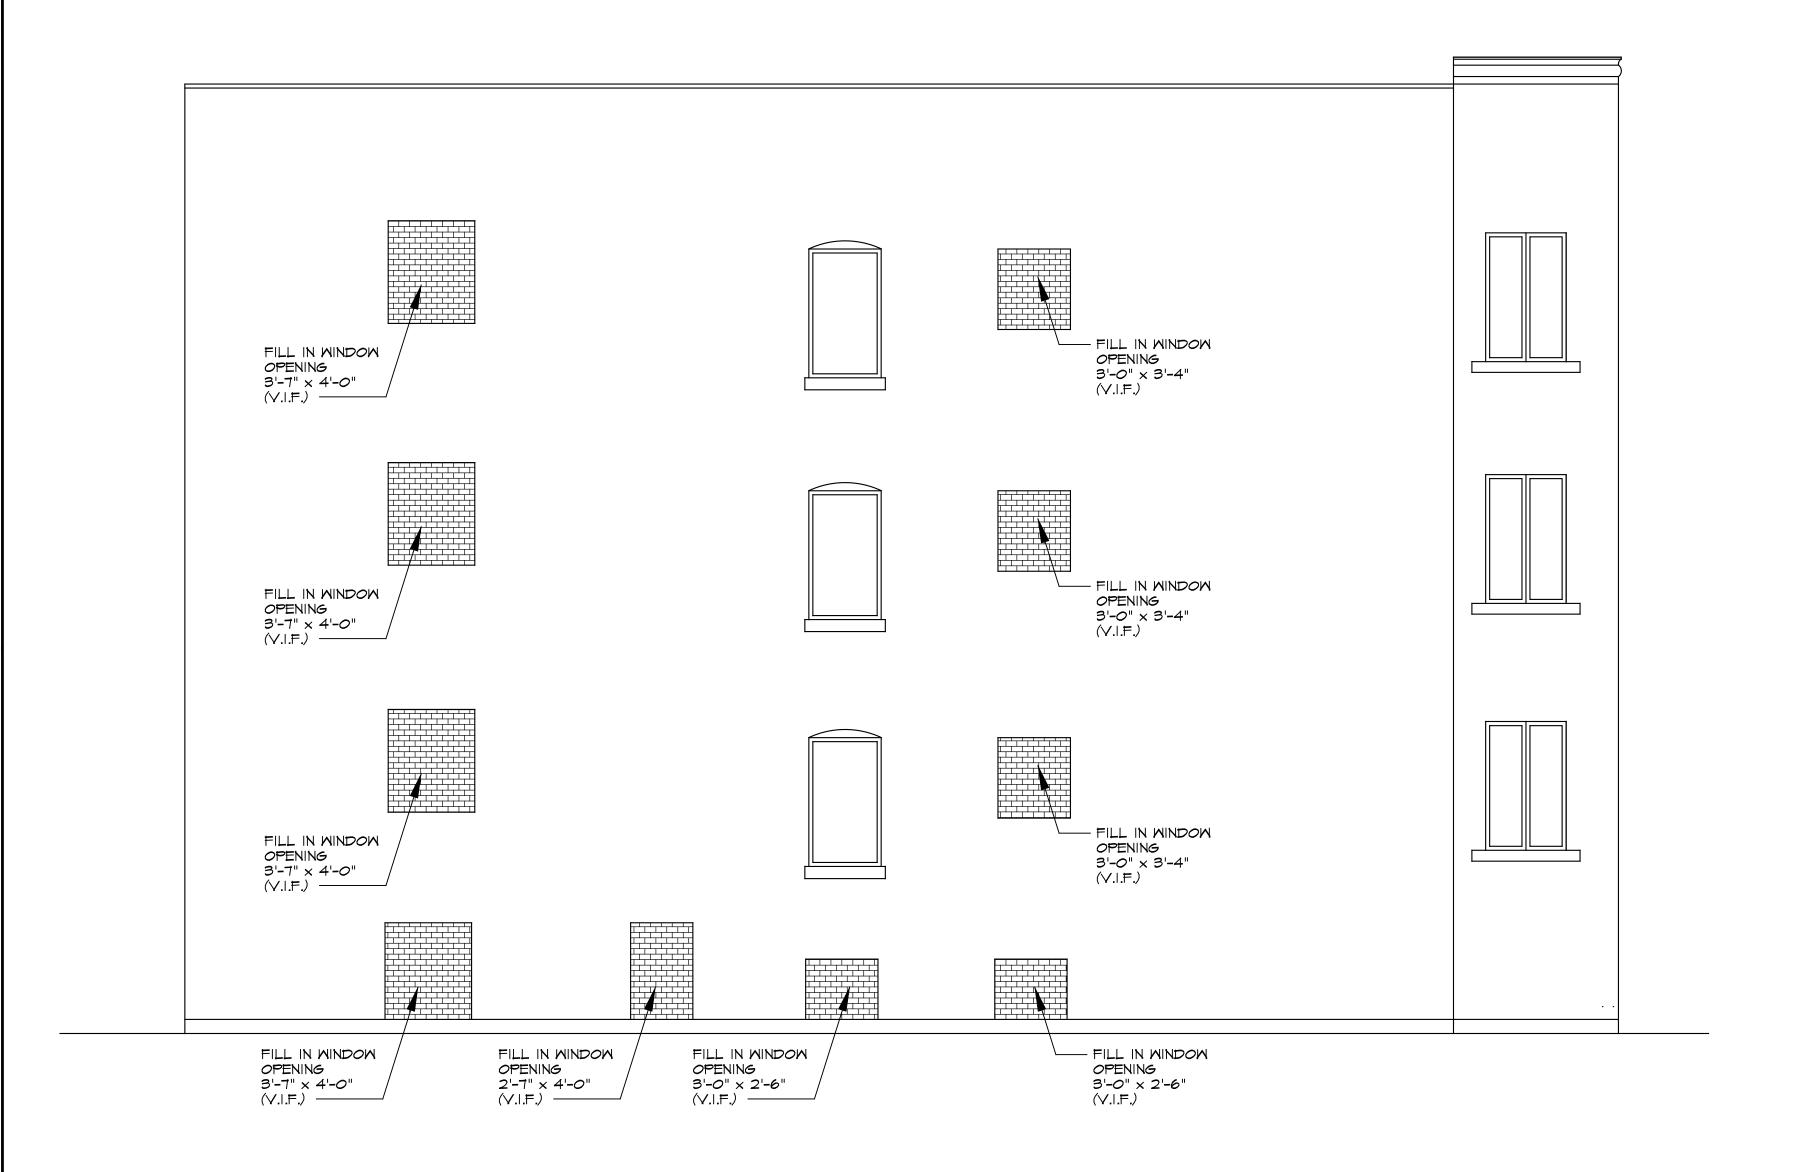


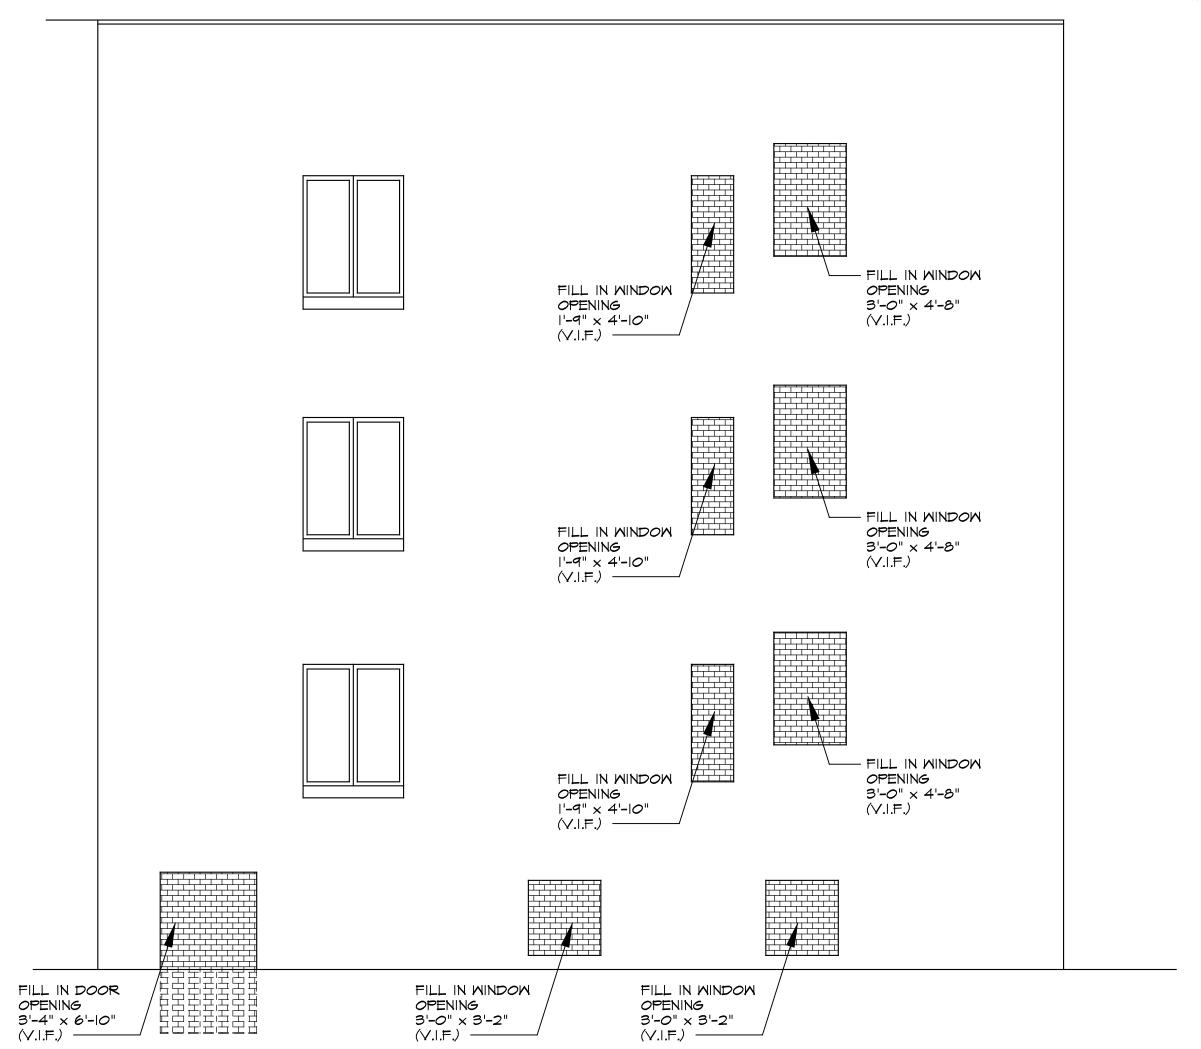

MEST ELEVATION MASONRY WORK

A-7 SCALE: 1/8" = 1'-0"



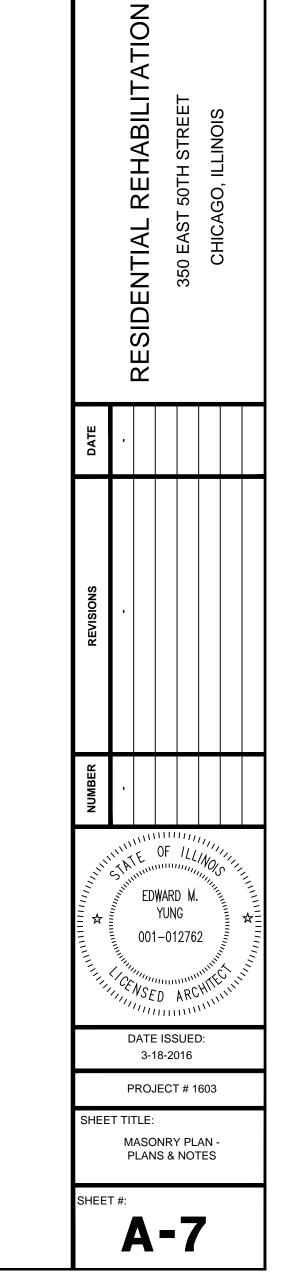

hitects